


# SHUSWAP NORTH OKANAGAN RAIL TRAIL

RE-VEGETATION GUIDELINES - STATION POINTS 00+000 TO 37+770

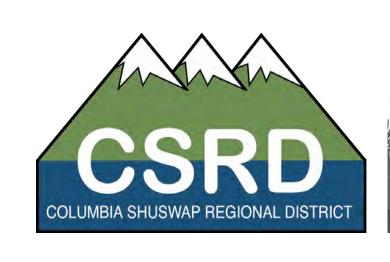







# SECTIONS

- PROJECT OVERVIEW + REVEGETATION GUIDELINES INTENT
- PLANT PALETTE INTEGRATION OF INDIGENOUS PLANTS AND TRADITIONAL KNOWLEDGE
- 3D VISUALIZATIONS OF NORTH OKANAGAN RAILTRAILTHROUGH ENDERBY TEST SECTION
- ENDERBY NORTH OKANAGAN RAILTRAIL SECTION ISSUED FOR TENDER DOCUMENTS
- SICAMOUS NARROWS NORTH OKANAGAN RAILTRAIL SECTION ISSUED FOR TENDER DOCUMENTS
- BASELINE CASE STUDIES: REVEGETATION OF 3 TYPICAL TREATMENT SECTIONS TO BE APPLIED TO OTHER SECTIONS
- NEXT STEPS














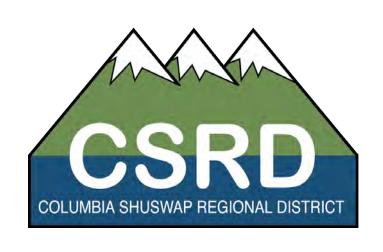



# RAIL TRAIL RE-VEGETATION PROJECT OVERVIEW


- Re-establish indigenous native plant habitats and improving overall ecosystem health along the rail trail corridor;
- Meaningful engagement with the Splatsin te Secwepemc to appropriately incorporate cultural values within the rail trail corridor;
- Develop three baseline conceptual re-vegetation prescriptions:
  - Natural Areas

  - Highly Impacted Areas (Enderby Linear Park)
     Impacted Areas adjacent to private homes (Sicamous Narrows)
- Cost effective, easily implementable, low maintenance design options;
- Explore the potential for phasing and grant funding applications
- Long term strategy for invasive plant mitigation and ongoing maintenance; and
- Target strategic re-vegetation (Spring 2024/25) precedent for future projects and as an example for fundraising.







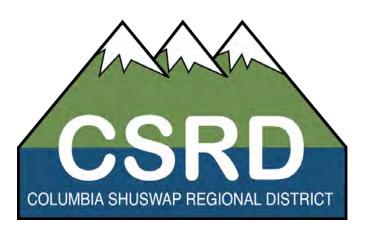



# RAIL TRAIL RE-VEGETATION GUIDELINES

## CONSISTENCY AND IN ALIGNMENT WITH OTHER RAIL TRAIL PLANS:

- + Shuswap North Okanagan Rail Trail Development Plan (STA 2021)
- + Construction and Signage Plan (Urban Systems)
- \* Riparian Areas Protection Regulation Assessment Report (QEP Assessment)
- + Maintenance Standards (2022)
- + Preliminary Trailhead Parking and Staging Area Phase 1 (2022/23)
- + Sicamous to Armstrong Rail Trail Development Agricultural Assessment (2020)



# INDIGENOUS PLANT PALETTE

The following are visual representations of some of the vegetation species re-vegetation guidelines. LARCH met collaboratively with Splatsin Representatives to expand approriate species for the Shuswap North Okanagan Rail Trail. This plant palette is intended for visual purposes and not intended to be considered a comprehensive list. Refer to Detailed Plant Schedules within tender packages. Where possible, consider local, acclimatized plant sources. Contact Landscape Architect or Splatsin Representative to substitute species based on availability.





**Mock Orange** Philadelphus lewisii



**Oregon Grape** *Mahonia aquifolium* 





**Coyote Willow** Salix exigua Saskatoon

Amelanchier alnifolia







Red Osier Dogwood



Kinnikinnick **Arctostaphylos** uva-ursi

**Dwarf Arctic** 

Salix purpurea

Willow

'Gracilis'

















Arnica + Balsmaroot





Blue Oat Grass Helictotrichon sempervirens



Coppertina Ninebark Physocarpus opulifolius



Mugo Pine Pinus mugo





**Douglas Fir** Pseudotsuga menziesii









**Tufted Hairgrass** 

Deschampsia

cespitosa

Acer glabrum

Populus tremuloides

Rocky Mountain Maple









Asteraceae Solidago

**Golden Rod** 

Birch Leaf Spirea


Spiraea betulifolia



Erythronium grandiflorum





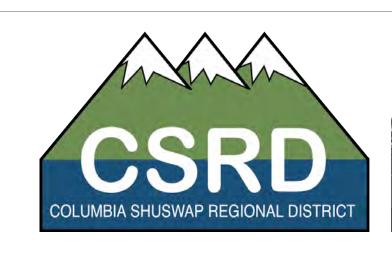










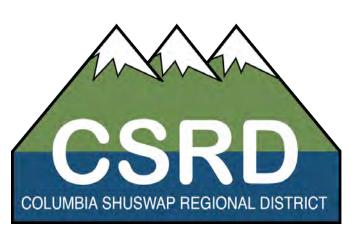




## SHUSWAP NORTH OKANAGAN RAIL TRAIL RE-VEGETATION GUIDELINES







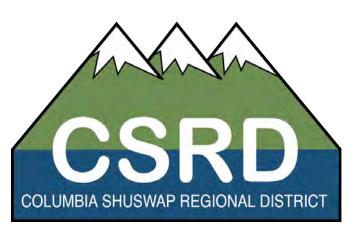














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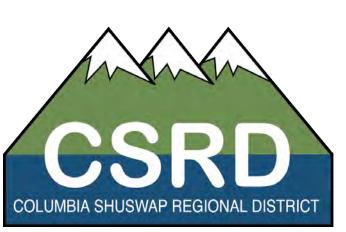


## SHUSWAP NORTH OKANAGAN RAIL TRAIL RE-VEGETATION GUIDELINES





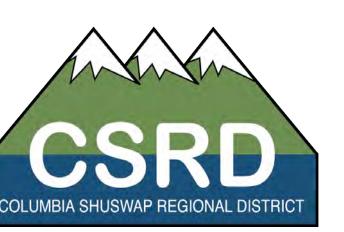





# SHUSWAP NORTH OKANAGAN RAIL TRAIL

ENDERBY TEST SECTION - STATION POINTS 35+800 TO 37+770

RE-VEGETATION PLAN - ISSUED FOR TENDER

## **DRAWING LIST:**

L1.0 REVEGETATION PLAN

L1.1 REVEGETATION PLAN

L1.2 REVEGETATION PLAN

L2.0 PLANT SCHEDULE

L2.1 REVEGETATION DETAILS

2023.07.11













2 REVEGATATION GUIDELINES PLAN - STATION POINTS 37+470 - 37+050 L1.1 1:500

**LEGEND** 

EXISTING UNDERGROUND UTILITIES PER CSRD DATA

EXISTING OVERHEAD UTILITIES PER CSRD DATA

EXISTING TREES TO REMAIN - PROTECT IN PLACE

PROPOSED VEGETATION REFER TO PLANT SCHEDULE

POTENTIAL FUTURE BACKED BENCH LOCATIONS PER RAIL TRAIL DEVELOPMENT PLAN STANDARD - NOT IN SCOPE

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POTENTIAL MICROFOREST PLANTING SITE IN COLLABORATION WITH SMALL WETLANDS ASSOCIATION PROPOSED COURSE CEDAR MULCH OR ANGULAR CHARCOAL ROCK MULCH TO 75mm (3" DEPTH) WITH TYPAR WEED BARRIER FABRIC OR APPROVED

EQUIVALENT APPROX. AREA: 400m2 (4,300 ft2)



APPROX. 500mm HT x 1000mm L x 500mm W

NORTH

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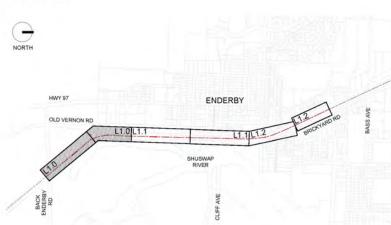
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PROJECT:

## SHUSWAP NORTH **OKANAGAN TRAIL**

LOCATION: ENDERBY, BC


KEY MAP:



SCALE: NTS

CLIENTS:



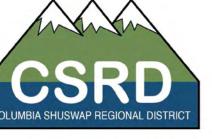



LANDSCAPE ARCHITECT





ISSUED FOR: TENDER

DATE: 2023-07-11


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REVISIONS:		
NO. DESCRIPTION.	DATE.	BY.
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DESIGNED BY: JJ		

DRAWING TITLE:

REVEGETATION PLAN

REVEGATATION GUIDELINES PLAN - STATION POINTS 37+050 - 36+730 L1.1 / 1:500

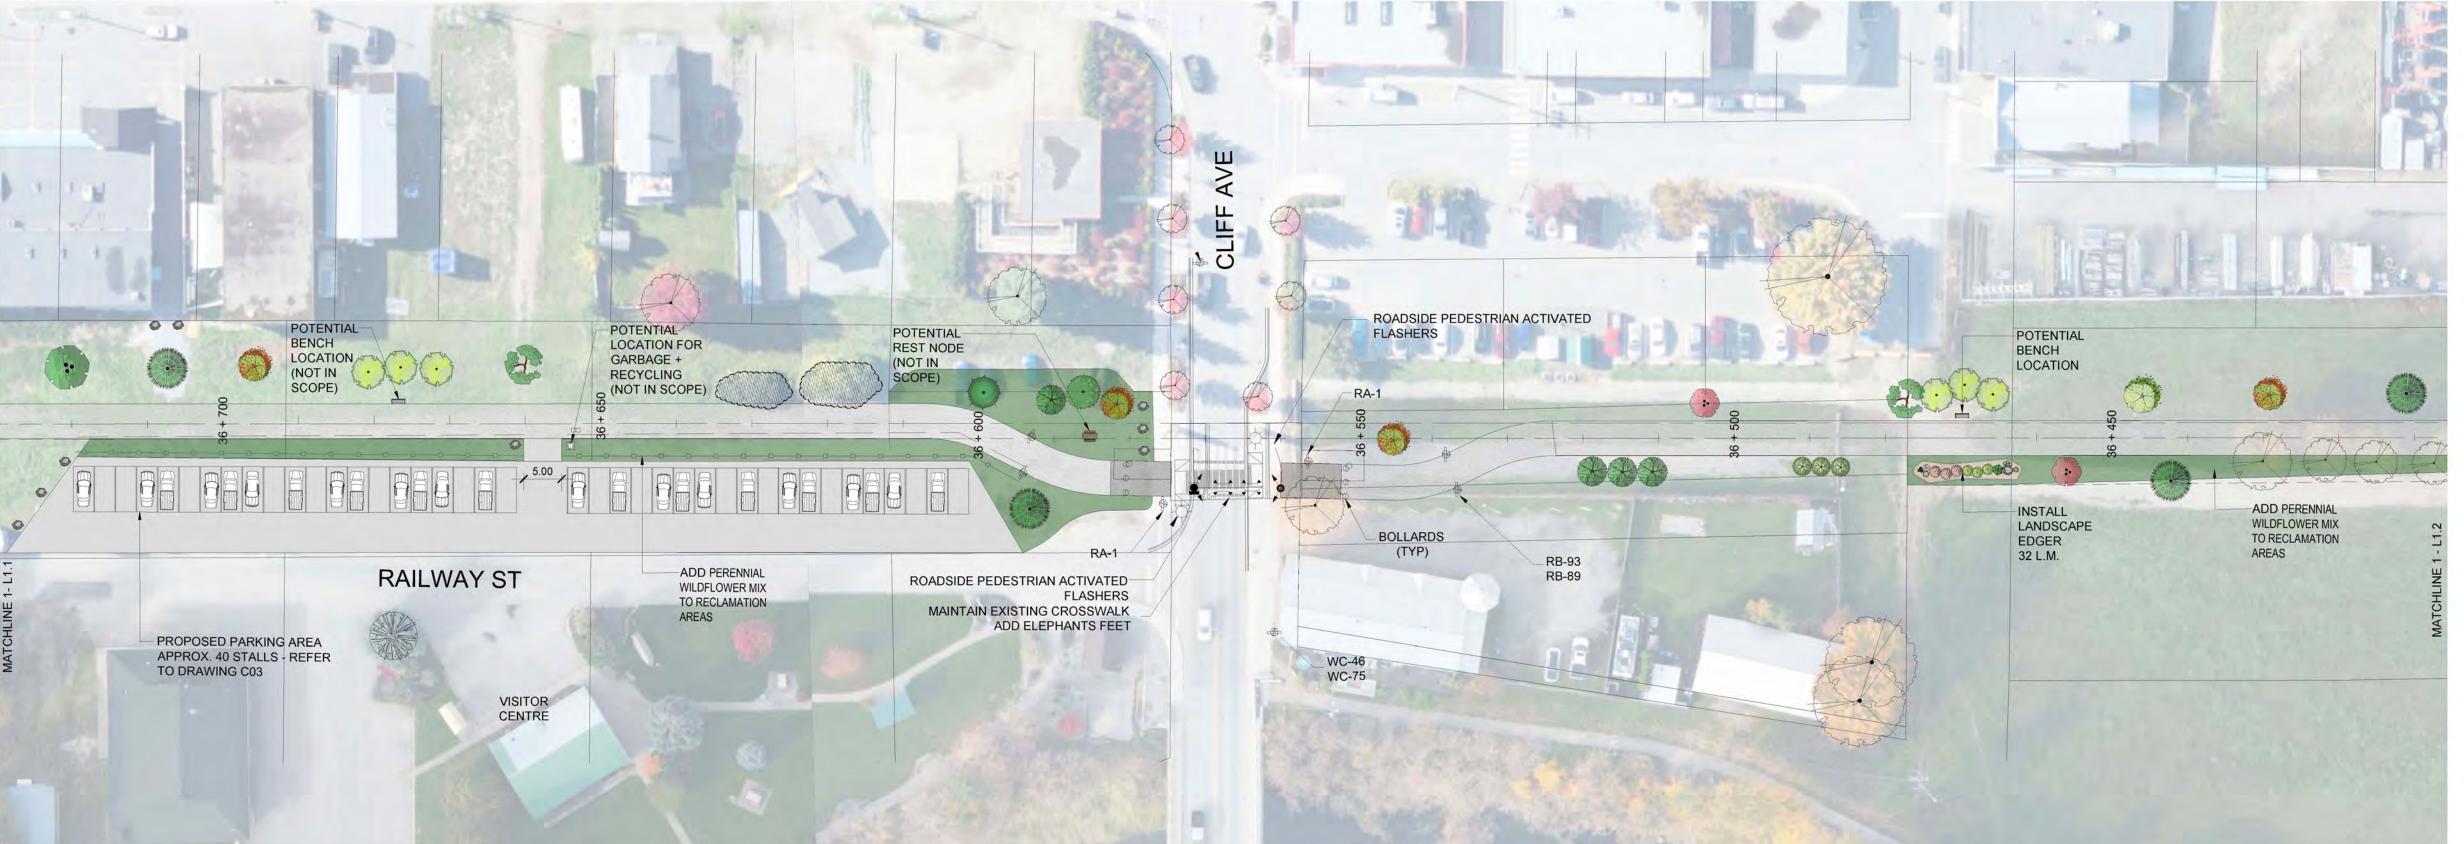

2 REVEGATATION GUIDELINES PLAN - STATION POINTS 36+740 - 36+410

**LEGEND** 

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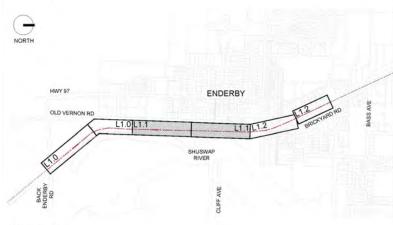
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PROJECT:

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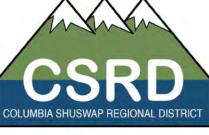
KEY MAP:



SCALE: NTS

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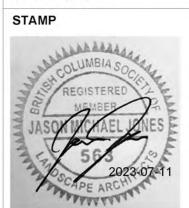




LANDSCAPE ARCHITECT



GOLDEN, BC



ISSUED FOR: TENDER

DATE: 2023-07-11

NOT FOR CONSTRUCTION

REVISIONS: NO. DESCRIPTION.	DATE.	BY.
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5. ISSUED FOR TENDER	2023-07-11	EL/JJ
DESIGNED BY: JJ		

DRAWING TITLE:

REVEGETATION PLAN

REVEGATATION GUIDELINES PLAN - STATION POINTS 36+410 - 36+080 L1.2 1:500



**LEGEND** 

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EXISTING OVERHEAD UTILITIES PER CSRD DATA

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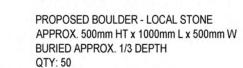
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PROJECT:

SHUSWAP NORTH **OKANAGAN TRAIL** 

LOCATION: ENDERBY, BC

KEY MAP:

SCALE: NTS

CLIENTS:







LANDSCAPE ARCHITECT



GOLDEN, BC



ISSUED FOR: TENDER

DATE: 2023-07-11

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DRAWING TITLE:

REVEGETATION PLAN

2 REVEGATATION GUIDELINES PLAN - STATION POINTS 36+080 - 35+650 L1.2 1:500

## PLANT SCHEDULE

	TREES ACE GIN	BOTANICAL / COMMON NAME Acer ginnala `Flame` / Flame Amur Maple Multi-Stem	CONT -	CAL 60mm	SIZE	QTY 3
	ACE SIL	Acer saccharinum 'Silver Cloud' / Silver Cloud Silver Maple		60mm		5
	ACE A12	Acer x freemanii `Jeffsred` / Autumn Blaze Maple	2 m	60mm		17
	BET PAP	Betula papyrifera / Paper Birch Multi-Stem 3-5 Trunks	- <u>-</u> -	60mm		3
	BET FAR	Betula platyphylla `Fargo` TM / Dakota Pinnacle Asian White Birch	-	50mm		9
	FRA PRA	Fraxinus pennsylvanica `Prairie Spire` / Prairie Spire Ash	-	60mm		6
0	LAR OCC	Larix occidentalis / Western Larch			2.0m HT.	6
	PIN PON	Pinus ponderosa / Ponderosa Pine			2.0m HT.	19
	PIN SYL	Pinus sylvestris / Scotch Pine			2.0m HT.	18
Son Co	POP TRE	Populus tremuloides / Trembling Aspen	- <del>-</del>	60mm		30
	PSE DOU	Pseudotsuga menziesii / Douglas Fir	.=		2.0m HT.	4
	TIL CO3	Tilia cordata `Corzam` / Corinthian Littleleaf Linden	-	60mm		5
	SHRUBS ACE GLA	BOTANICAL / COMMON NAME Acer glabrum / Rocky Mountain Maple	CONT #5 CONT.			21
	AME SER	Amelanchier alnifolia / Saskatoon	#2 CONT.			9
0	CAL KAR	Calamagrostis x acutiflora `Karl Foerster` / Feather Reed Grass	#2 CONT.			5
	COR MID	Cornus sanguinea 'Midwinter Fire' / Midwinter Fire Bloodtwig Dogwood	#5 CONT.			6
	COR RE5	Cornus sericea / Red Osier Dogwood	#2 CONT.			15
· William	DES BRO	Deschampsia cespitosa `Bronzeschleier` / Tufted Hair Grass	#2 CONT.			4
	MAH AQU	Mahonia aquifolium / Oregon Grape	#2 CONT.			6
	MON CAM	Monarda x `Cambridge Scarlet` / Red Bee Balm	#2 CONT.			6
	PER ATR	Perovskia atriplicifolia / Russian Sage	#2 CONT.			4
	PHI BLI	Philadelphus lewisii `Blizzard` / Blizzard Mockorange	#5 CONT.			12
	PHY COP	Physocarpus opulifolius `Coppertina` / Coppertina Ninebark	#5 CONT.			6
	PIN CO2	Pinus mugo `Compacta` / Dwarf Mugo Pine	#5 CONT.			4
	RUD GO2	Rudbeckia fulgida sullivantii `Goldsturm` / Black-eyed Susan	#1 CONT.			15
	SAL PUR	Salix purpurea `Nana` / Dwarf Arctic Willow	#2 CONT.			10
0	SAL CAR	Salvia nemorosa `Caradonna` / Cardonna Perennial Salvia	#1 CONT.			9

PROPOSED NATIVE RECLAMATION SEED MIX

TIPI MOUNTAIN NATIVE RECLAMATION GRASS SEED MIX TO BE HYDROSEEDED WITH TACKIFIER AT 200 KG/HECTARE, FERTILIZER AT 250KG/HECTARE.

ADD COMBINED WITH WEST COAST SEEDS - PERENNIAL WILDFLOWER MIX 625 GRAMS INTO NATURAL SEED MIX IN AREAS NOTED ON REVEGETATION DRAWINGS

ALTERNATIVE MIX OR APPROVED EQUIVALENT:

REVEGETATION MIX BY TOP CROP CRANBROOK ITEM# FRXT6108

LEGEND EXISTING UNDERGROUND UTILITIES PER CSRD DATA

> EXISTING TREES TO REMAIN - PROTECT IN PLACE

PROPOSED VEGETATION REFER TO PLANT SCHEDULE

POTENTIAL FUTURE BACKED BENCH LOCATIONS PER RAIL TRAIL DEVELOPMENT PLAN STANDARD - NOT IN SCOPE

POTENTIAL FUTURE LOCATION FOR BEAR PROOF GARBAGE AND RECYCLING BINS - NOT IN SCOPE

PROPOSED RECLAMATION SEED MIX AREAS - 150mm TOPSOIL AND HYDROSEED - REFER TO L2.0 QTY: 1,950 m2 (21,000 ft2) APPLY TACKIFIER OR BIODEGRADABLE EROSION CONTROL MATTING ON ANY SLOPES EXCEEDING 3:1 POTENTIAL MICROFOREST PLANTING SITE IN

COLLABORATION WITH SMALL WETLANDS ASSOCIATION PROPOSED COURSE CEDAR MULCH OR ANGULAR CHARCOAL ROCK MULCH TO 75mm (3" DEPTH)

WITH TYPAR WEED BARRIER FABRIC OR APPROVED EQUIVALENT APPROX. AREA: 400m2 (4,300 ft2) PROPOSED BOULDER - LOCAL STONE APPROX. 500mm HT x 1000mm L x 500mm W BURIED APPROX. 1/3 DEPTH

QTY: 50

## **GENERAL NOTES:**

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- 4. CONTRACTOR TO VERIFY ALL DIMENSIONS AND REPORT ANY DISCREPANCIES TO ENGINEER OR LANDSCAPE ARCHITECT. PROPERTY LINES TO BE VERIFIED PRIOR TO CONSTRUCTION.
- 5. CONTRACTOR IS RESPONSIBLE TO COORDINATE THE STAGING OF CONSTRUCTION ACTIVITIES AND WORK WITH ALL OTHER CONTRACTORS ONSITE, INCLUDING SLEEVING AND WEEPING TILE DOWNSPOUT LOCATIONS PRIOR TO HARDSCAPE /SOFTSCAPE INSTALLATION.
- 6. THE LANDSCAPE ARCHITECT WILL BE NOTIFIED MIN. 48 HOURS PRIOR TO COMMENCEMENT OF WORK.
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## PLANTING NOTES:

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2. CONFINE EQUIPMENT AND WORKERS TO LIMIT OF DISTURBANCE WITHIN PROJECT BOUNDARY.

3. MINIMUM 150mm OF TOPSOIL AND SEED MIX TO BE PLANTED ADJACENT TO DISTURBED AREAS AND OTHER AREAS OF NEW CONSTRUCTION.

4. PLANT MATERIAL SHALL MEET ALL REQUIREMENTS OF THE LATEST EDITION OF THE CANADIAN NURSERY TRADES ASSOCIATION GUIDE SPECIFICATIONS FOR NURSERY STOCK UNLESS OTHERWISE SPECIFIED.

5. SUPPLY 75mm OF NATURAL COLOUR CEDAR BARK MULCH OR ANGULAR ROCK MULCH TO ALL PROPOSED TREE AND SHRUB BEDS.

6. INSTALL TREE GATOR BAG - SLOW RELEASE WATERING SYSTEM (OR APPROVED EQUIVALENT) ON ALL PROPOSED DECIDUOUS TREES AND TREE GATOR JR. PRO LOW PROFILE - SLOW RELEASE WATERING SYSTEM (OR APPROVED EQUIVALENT) ON ALL PROPOSED CONIFEROUS TREES.

6. TREES AND SHRUBS TO BE GUARANTEED FOR 1 FULL GROWING SEASONS BY CONTRACTOR. ALL REPLACEMENTS TO BE AT CONTRACTOR'S EXPENSE. SUBSTITUTIONS TO BE APPROVED BY LANDSCAPE ARCHITECT.

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2. GROWING MEDIUM SHOULD BE CERTIFIED TO IT'S ORIGIN AND VIRTUALLY FREE OF INVASIVE PLANT SEEDS, THEIR REPRODUCTIVE PARTS AND ROOTS, BUILDING MATERIALS, INVASIVE OR NOXIOUS PLANTS, NON COMPOSTED WOOD, WOOD WASTE, INSECT PESTS, PLANT PATHOGENIC ORGANISMS, CHEMICAL POLLUTANTS OR SUBSTANCES AT LEVELS TOXIC TO PLANTS, AND OTHER EXTRANEOUS MATERIALS THAT DETRACT FROM DESIRABLE PHYSICAL AND CHEMICAL PROPERTIES REQUIRED FOR LANDSCAPING PURPOSES.

LOAM: NATURAL, FERTILE, FRIABLE, AGRICULTURAL SOIL MEETING


- FOLLOWING REQUIREMENTS: NOT LESS THAN 6% ORGANIC MATERIAL.
- PH VALUE RANGING FROM 5.9 TO 7.0. NON-TOXIC TO PLANT GROWTH.
- E.C.- SALINITY READING NOT EXCEEDING 1.5.
- SOIL TEXTURE: LOAM SOIL AS DEFINED BY CANADIAN SYSTEM OF SOIL CLASSIFICATION.

PEAT MOSS: DECOMPOSED PLANT MATERIAL, FAIRLY ELASTIC AND HOMOGENEOUS, FREE OF DECOMPOSED COLLOIDAL RESIDUE. WOOD, SULPHUR, AND IRON. MINIMUM OF 80% ORGANIC MATTER BY MASS; PH VALUE BETWEEN 4.5 AND 6.0.

## PROJECT:


## SHUSWAP NORTH **OKANAGAN TRAIL**

LOCATION: ENDERBY, BC

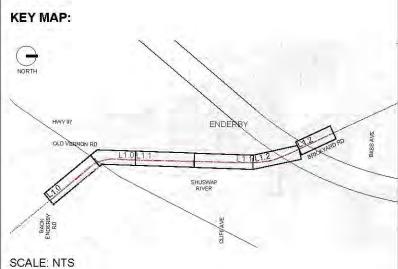

CLIENTS:



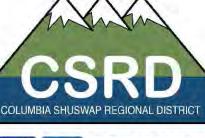



LANDSCAPE ARCHITECT





NOTE: ORIGINAL SIZE ARCH D (24x36")

ISSUED FOR: TENDER

DATE: 2023-07-11


## NOT FOR CONSTRUCTION

DATE.	BY.
2022-11-02	EL/JJ
2022-12-19	EL/JJ
2023-02-03	EL/JJ
2023-03-02	EL/JJ
2023-07-11	EL/JJ
	2022-11-02 2022-12-19 2023-02-03 2023-03-02


DRAWING TITLE : PLANT SCHEDULE


- WATER THOROUGHLY AFTER INSTALLATION. INSTALL TREE STAKES IF REQUIRED BY CLIENT
- REMOVE TREE RINGS AND STAKES TWO YEARS AFTER INSTALLATION. 4. DO NOT ALLOW AIR POCKETS TO FORM WHEN BACKFILLING.
- . POSITION CROWN OF ROOT BALL 50mm ABOVE FINISHED GRADE TO ALLOW FOR SETTLEMENT. 6. DEPTH OF ROOTBALL TO MATCH ORIGINAL ROOTBALL DEPTH ESTABLISHED IN THE NURSERY. ANY TREES PLANTED TOO
- LOW WILL BE RAISED AT THE CONTRACTOR'S EXPENSE. DO NOT DAMAGE OR CUT LEADER. 8. IF STAKING IS DEEMED NECESSARY REFER TO TREE STAKING
- 9. DO NOT WRAP TRUNK.
- 10. INSTALL TREE GATOR WATERING SYSTEM PER MANUFACTURER SPECIFICATIONS.
- 11. ALL TREE AND SHRUB PLANTING TO MEET THE CANADIAN LANDSCAPE STANDARD SPECIFICATIONS, CURRENT EDITION.



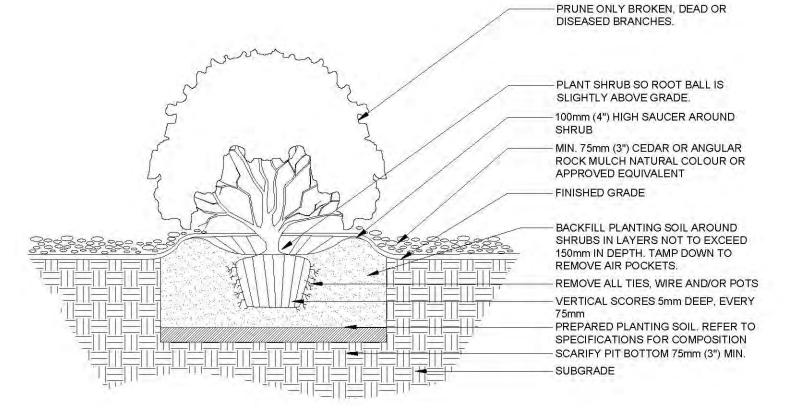


2 SHRUB PLANTING DETAIL L2.1 / 1:30

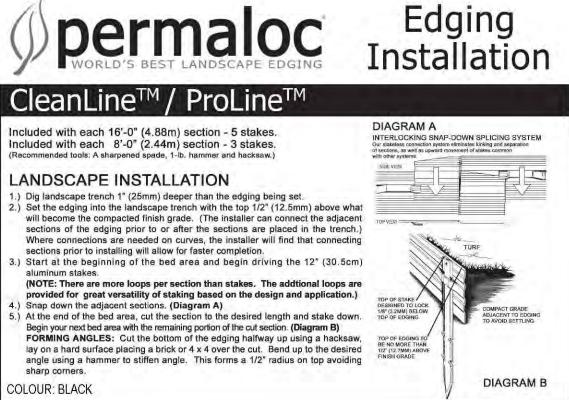

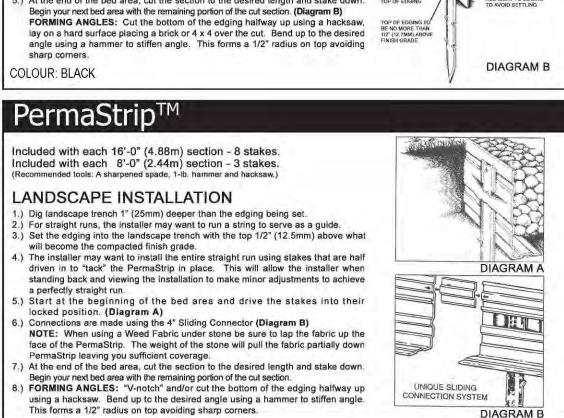


For more information, contact us at 1.800.356.9660



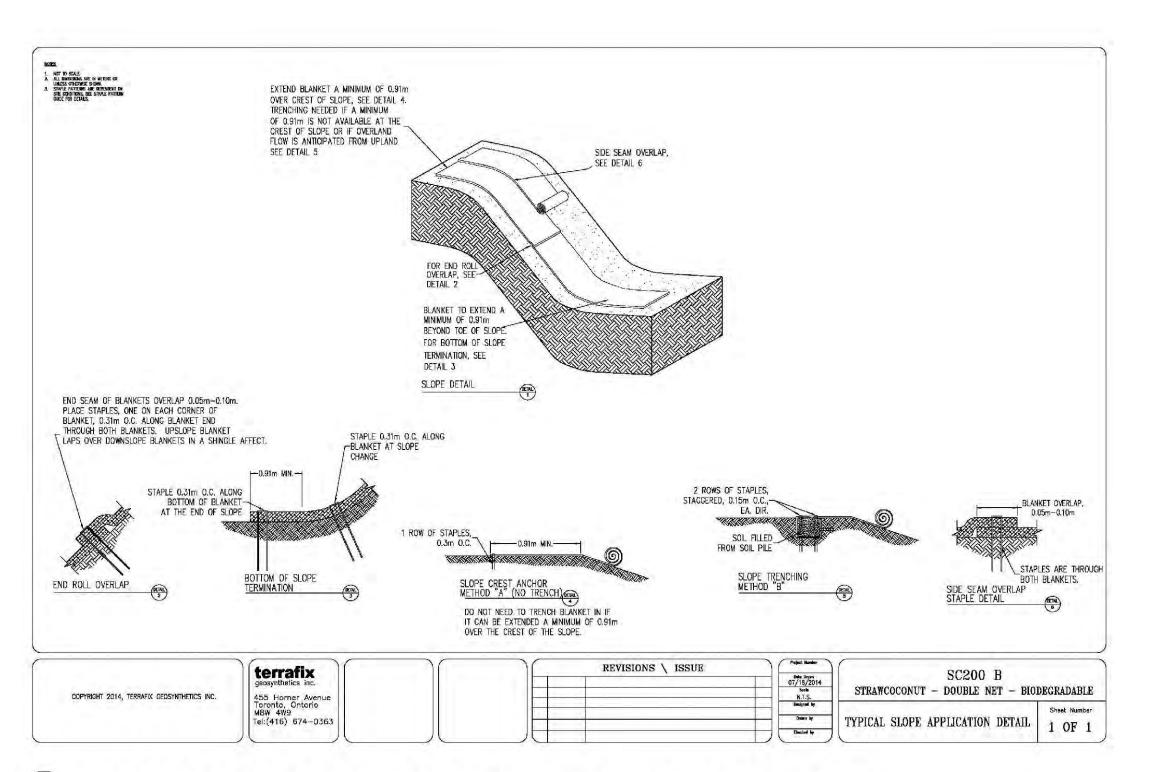

BIODEGRADABLE EROSION CONTROL MATTING INFORMATION OR APPROVED EQUIVALENT

## LEGEND

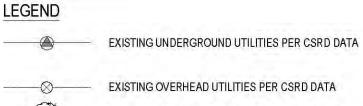

EXISTING TREES TO REMAIN - PROTECT IN PLACE

PROPOSED VEGETATION REFER TO PLANT SCHEDULE

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PROPOSED BOULDER - LOCAL STONE APPROX. 500mm HT x 1000mm L x 500mm W BURIED APPROX. 1/3 DEPTH QTY: 50

EQUIVALENT APPROX. AREA: 400m2 (4,300 ft2)

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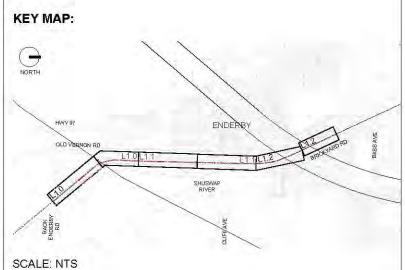
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PROJECT:

## SHUSWAP NORTH OKANAGAN TRAIL

LOCATION: ENDERBY, BC



CLIENTS:





LANDSCAPE ARCHITECT





NOTE: ORIGINAL SIZE ARCH D (24x36")

NORTH ISSUED FOR: TENDER

DATE: 2023-07-11

NOT FOR CONSTRUCTION

REVISIONS: NO. DESCRIPTION. DATE. 2022-11-02 1. PRELIMINRY DISCUSSION 2022-12-19 EL/J 2. PRELIMINRY CONCEPT 3. SPLATSIN ENGAGEMENT 2023-02-03 4. COMMITTEE REVIEW 2023-03-02 5. ISSUED FOR TENDER 2023-07-11 EL/J. DESIGNED BY: JJ

**DRAWING TITLE:** REVEGETATION DETAILS

## Shuswap North Okanagan Rail Trail

Project #

Total

2023-09-20

Issued for Tender - Unit Price Schedule City of Enderby

v of Enderby

Unit

Qty

**Unit Cost** 

619 Cliff Avenue, Enderby, BC V0E 1V0

Item / Description

1.	CONTRACTOR USE OF SITE, SITE ACCESS, AND SITE SURVEY				
	i. Contractor mobilization, establishment of site security fencing, secure staging compound, installation of stockpile areas, tree protection fencing, maintain temporary access routes, safety signage, detours, and haul roads as required. Reinstatement of all areas, surfaces and utilities disturbed. Remove construction debris and demobilization. Contractor to submit location of staging area, stockpile location and sizes, haul routes to City of Enderby representatives and Landscape Architect for approval prior to mobilization.	l.sum	1		
			Sul	b-Total Section 1	
2.	REVEGETATION + LANDSCAPE				
	A. Trees				
	i. Acer ginnala `Flame` / Flame Amur Maple				
	*Per Landscape drawings and specifications.	ea.	3		
	ii. Acer saccharinum 'Silver Cloud' / Silver Cloud Silver Maple				
	*Per Landscape drawings and specifications.	ea.	5		
	iii. Acer x freemanii `Jeffsred` / Autumn Blaze Maple				
	*Per Landscape drawings and specifications.	ea.	17		
	iv. Betula papyrifera / Paper Birch				
	*Per Landscape drawings and specifications.	ea.	3		
	v. Betula platyphylla `Fargo` TM / Dakota Pinnacle Asian White Birch				
	*Per Landscape drawings and specifications.	ea.	9		
	vi. Fraxinus pennsylvanica `Prairie Spire` / Prairie Spire Ash				
	*Per Landscape drawings and specifications.	ea.	6		
	vii. Larix occidentalis / Western Larch				
	*Per Landscape drawings and specifications.	ea.	6		
	viii. Pinus ponderosa / Ponderosa Pine				
	*Per Landscape drawings and specifications.	ea.	19		
	ix. Pinus sylvestris / Scotch Pine				
	*Per Landscape drawings and specifications.	ea.	18		
	x. Populus tremuloides / Trembling Aspen				
	*Per Landscape drawings and specifications.	ea.	30		
	xi. Pseudotsuga menziesii / Douglas Fir				
	*Per Landscape drawings and specifications.	ea.	4		
	xii. Tilia cordata `Corzam` / Corinthian Littleleaf Linden				
	*Per Landscape drawings and specifications.	ea.	5		

2023-09-20

## Issued for Tender - Unit Price Schedule City of Enderby

619 Cliff Avenue, Enderby, BC V0E 1V0

Item / Description	Unit	Qty	Unit Cost	Total
B. Shrubs, Grasses, Perennials i. Acer glabrum / Rocky Mountain Maple				
*Per Landscape drawings and specifications.	ea.	21		
ii. Amelanchier alnifolia / Saskatoon	ou.	21		
*Per Landscape drawings and specifications.	ea.	9		
iii. 'Karl Foerster' Feather Reed Grass	ou.	Ü		
*Per Landscape drawings and specifications.	ea.	5		
iv. Cornus sanguinea 'Midwinter Fire' / Midwinter Fire Bloodtwig Dogwood	ou.	Ü		-
*Per Landscape drawings and specifications.	ea.	6		
v. Cornus sericea / Red Osier Dogwood		ŭ		
*Per Landscape drawings and specifications.	ea.	15		
vi. Deschampsia cespitosa `Bronzeschleier` / Tufted Hair Grass				
*Per Landscape drawings and specifications.	ea.	4		
vii. Mahonia aquifolium / Oregon Grape				•
*Per Landscape drawings and specifications.	ea.	6		
viii. Monarda x `Cambridge Scarlet` / Red Bee Balm				
*Per Landscape drawings and specifications.	ea.	6		
ix. Perovskia atriplicifolia / Russian Sage				-
*Per Landscape drawings and specifications.	ea.	4		
x. Philadelphus lewisii `Blizzard` / Blizzard Mockorange				•
*Per Landscape drawings and specifications.	ea.	12		
xi. Physocarpus opulifolius `Coppertina` / Coppertina Ninebark				•
*Per Landscape drawings and specifications.	ea.	6		
xii. Pinus mugo `Compacta` / Dwarf Mugo Pine				
*Per Landscape drawings and specifications.	ea.	4		
xiii. Rudbeckia fulgida sullivantii `Goldsturm` / Black-eyed Susan				
*Per Landscape drawings and specifications.	ea.	15		
xiv. Salix purpurea `Nana` / Dwarf Arctic Willow				
*Per Landscape drawings and specifications.	ea.	10		
xv. Salvia nemorosa `Caradonna` / Cardonna Perennial Salvia	Ju.	.0		-
*Per Landscape drawings and specifications.	ea.	9		
	ca.	J		

## **Shuswap North Okanagan Rail Trail**

Project #

2023-09-20

Issued for Tender - Unit Price Schedule City of Enderby

y of Enderby

619 Cliff Avenue, Enderby, BC V0E 1V0

tem / Description	Unit	Qty	Unit Cost	Total
C. Landscape Items i. Feature Boulders				
*Per Landscape drawings. Supply and install local source feature boulders approx. 1000mm L x 500mm H x 500mm W.	ea.	50		
ii. Landscape Edger	ou.	-		
*Per Landscape drawings. Supply and install Permaloc cleanline black metal edger or approved equivalent.	l.m.	130		
iii. Tree Gator Watering Bag (Deciduous Trees)				
*Per Landscape drawings. Supply and install Gator Bag Pro or approved equivalent.	e.a.	78		
iv. Tree Gator Jr. Watering Bag (Coniferous Trees)				
*Per Landscape drawings. Supply and install Gator Bag Pro or approved equivalent.	e.a.	47		
D. Planting Medium - Topsoil i. Planting Medium for Tree and Shrub Beds	5.5.			
*Supply and install screened topsoil to 1000mm depth per specifications including soil amendments per landscape drawings and specifications to all planting areas.	cu.m	250		
ii. Topsoil for reclamation areas	ou.m	-		
*Supply and install screened topsoil to 150mm depth in reclamation seed mix areas.	cu.m	275		
E. Landscape Mulch				
i. Bark Mulch *Supply and installation of course natural colour cedar bark or rock mulch including TYPAR landscape fabric underlay (or approved equivalent) per landscape drawings and specifications.	sq.m	250		
		Sub	-Total Section 2	
			Total	

#### NOTE:

<sup>\*</sup> Contractor is to ensure all items listed above are supplied, installed, and maintained in accordance with City of Enderby Development Guidelines & Standard Specifications and MMCD (Current Edition)

<sup>\*</sup> All quantities and areas are to be confirmed prior to construction


# RAIL TRAIL RE-VEGETATION PROJECT OBJECTIVES

- Develop three baseline conceptual re-vegetation prescriptions:
   Highly Impacted Areas (Enderby Linear Park)
   Impacted Areas adjacent to private homes (Sicamous Narrows)
  - Natural Areas (Remote Rail Trail Locations)
- Re-establish indigenous native plant habitats and improving overall ecosystem health along the rail trail corridor;
- Meaningful engagement with the Splatsin te Secwepemc to appropriately incorporate cultural values within the rail trail corridor;
- Cost effective, easily implementable, low maintenance design options;
- Explore the potential for phasing and grant funding applications
- Long term strategy for invasive plant mitigation and ongoing maintenance; and
- Target re-vegetation (Spring 2025) precedent for future projects and as an example for fundraising.







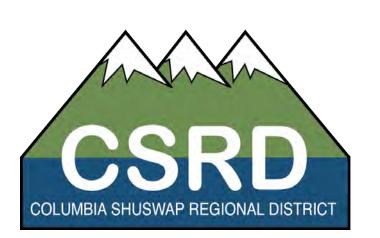



# SICAMOUS NARROWS RAIL TRAIL RE-VEGETATION DIRECTION

The following represents a summary of the direction provided by the Technical Rail Trail Operating Committee for the Revegatation Plan for the Sicamous Narrows trail corridor section moving forward toward Tender Documents.


- The Rail Trail Corridor runs through Indigenous Traditional Territory
   All disturbance requires archaeological assessment (cultural artifacts)

  - Increase awareness of Splatsin presence
  - Utilize vegetation to protect sensitive areas and habitat
  - Re-establish indigenous native plant habitats and improving overall ecosystem health along the rail trail corridor;
- This corridor will be disturbed during construction, it represents an opportunity address areas of encroachment within the corridor. It is incumbent on land owners to protect and restore the corridor and sensitive riparian habitat from encroachment and disturbance;
- The Revegetation Plan will be respectful of access and existing views wherever possible;
- Opportunities for homeowners to explore bylaw applications for variances within the corridor







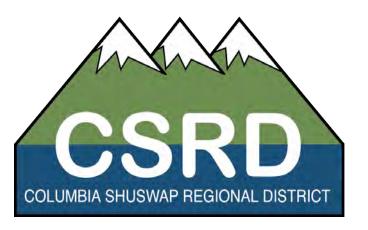



# SHUSWAP NORTH OKANAGAN RAIL TRAIL

SICAMOUS SECTION - STATION POINTS 0+500 TO 1+500

RE-VEGETATION PLAN - ISSUED FOR TENDER

## **DRAWING LIST:**

L1.0 REVEGETATION PLAN

L1.1 REVEGETATION PLAN

L1.2 REVEGETATION PLAN


L2.0 PLANT SCHEDULE

L2.1 REVEGETATION DETAILS

2024.07.02





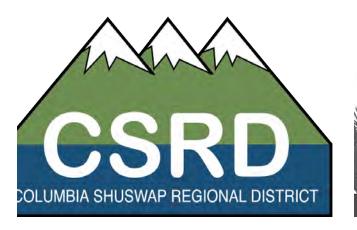








2 REVEGATATION GUIDELINES PLAN - STATION POINTS 0+440 - 0+760 L1.0 1:500

## LEGEND

EXISTING LOT LINES, UTILITIES, UNDERGROUND SERVICES PER CSRD DATA

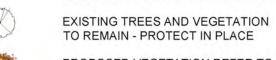

PROPOSED VEGETATION REFER TO PLANT SCHEDULE

PROPOSED RECLAMATION SEED MIX AREAS - 150mm TOPSOIL AND HYDROSEED - REFER TO L2.0 QTY: 2,850 m2 (30,700 ft2) APPLY TACKIFIER OR BIODEGRADABLE EROSION CONTROL MATTING ON ANY SLOPES **EXCEEDING 3:1** 

### **GENERAL NOTES:**

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- ALL WORK AND MATERIALS ARE TO BE IN ACCORDANCE WITH THE CURRENT EDITIONS OF THE CITY OF SICAMOUS CONSTRUCTION STANDARDS, AND THE MASTER MUNICIPAL CONSTRUCTION DOCUMENTS (MMCD) REQUIREMENTS.
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5. SUPPLY 75mm OF NATURAL COLOUR CEDAR BARK MULCH OR ANGULAR ROCK MULCH TO ALL PROPOSED TREE AND SHRUB BEDS.

6. INSTALL TREE GATOR BAG - SLOW RELEASE

WATERING SYSTEM (OR APPROVED EQUIVALENT) ON ALL PROPOSED **DECIDUOUS** TREES AND TREE GATOR JR. PRO LOW PROFILE - SLOW

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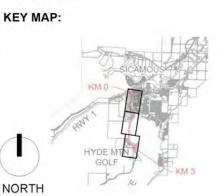
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PROJECT:

## SHUSWAP NORTH OKANAGAN TRAIL 0km-3km SICAMOUS - ARMSTRONG

LOCATION: SICAMOUS, BC









LANDSCAPE ARCHITECT



GOLDEN, BC



ORIGINAL SHEET SIZE ARCH D 24X36

NORTH SCALE 1:1500


ISSUED FOR: DRAFT ISSUED FOR TENDER

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**DRAWING TITLE:** REVEGETATION PLAN


REVEGATATION GUIDELINES PLAN - STATION POINTS 0+760 - 1+060 L1.1 1:500



2 REVEGATATION GUIDELINES PLAN - STATION POINTS 1+060 - 1+380 L1.1 1:500
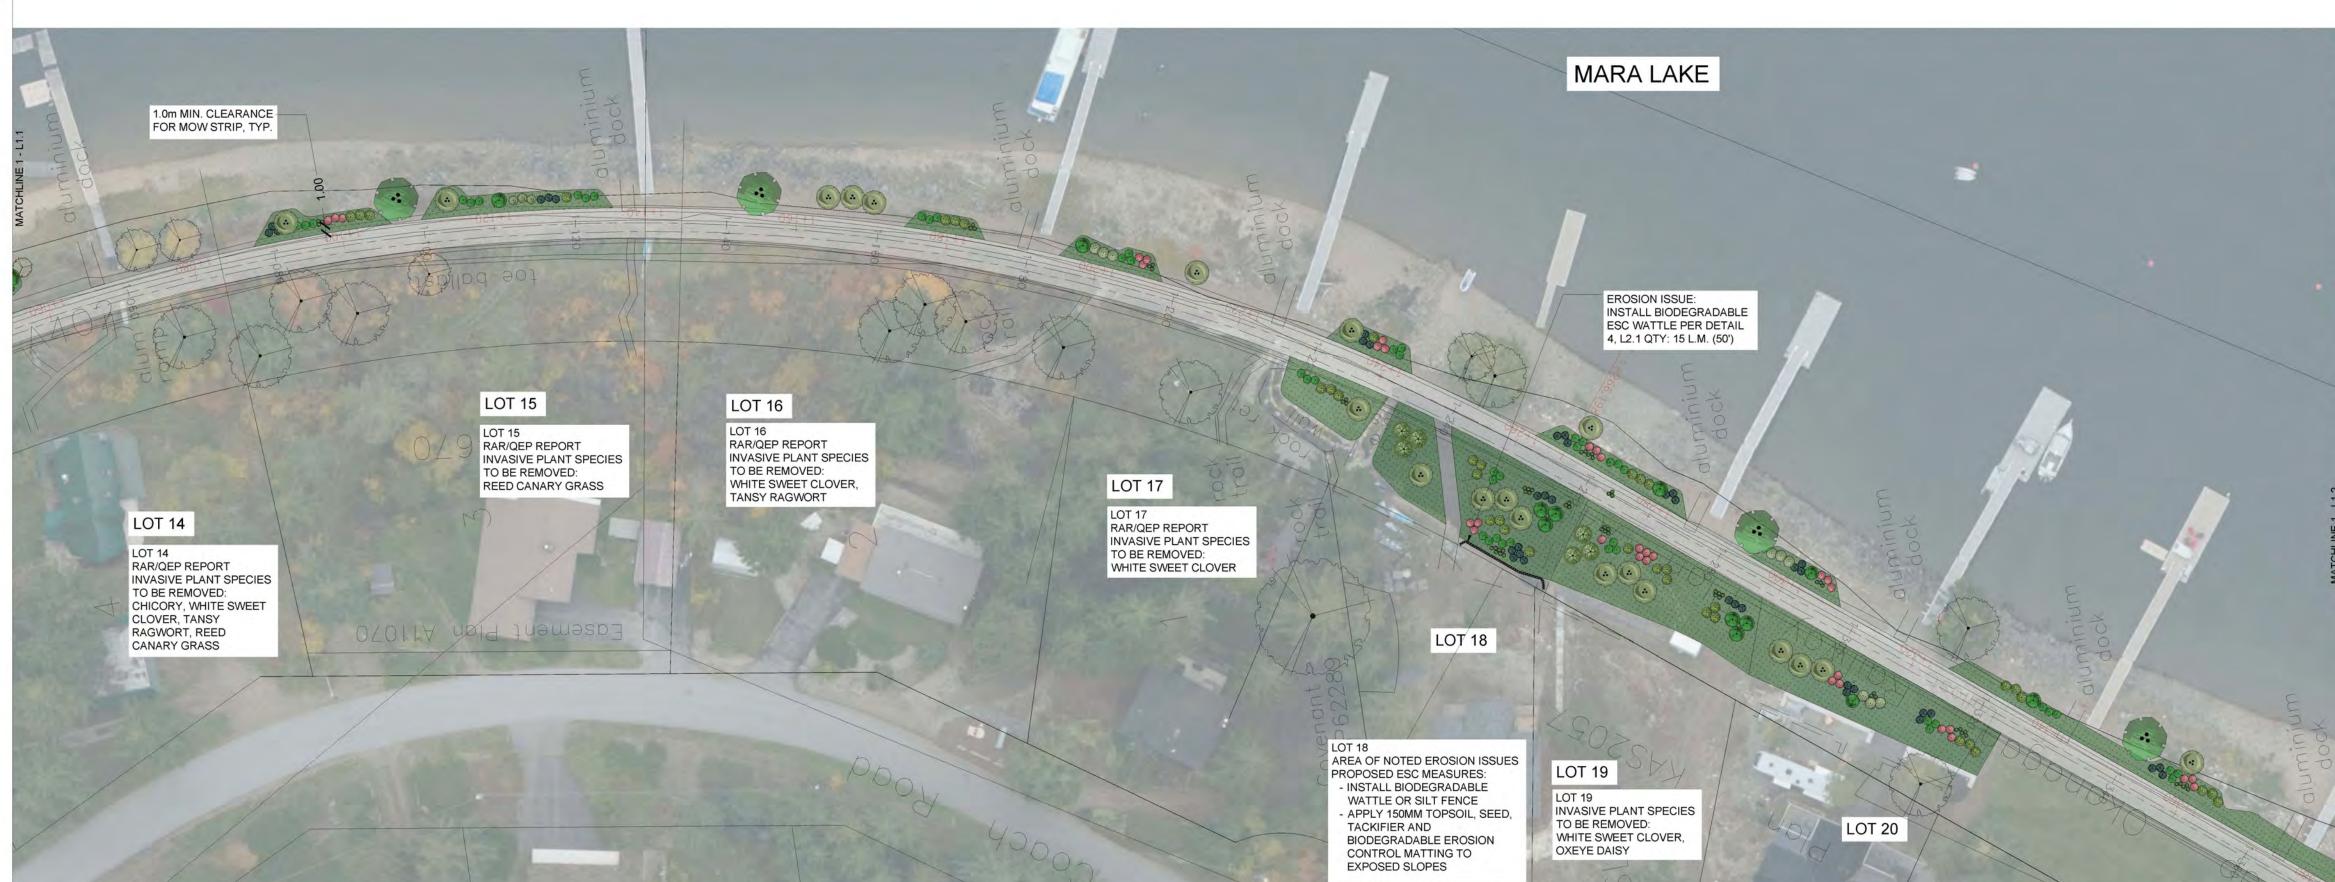
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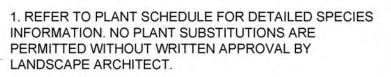
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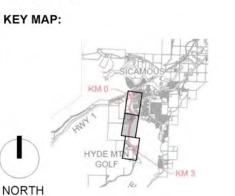
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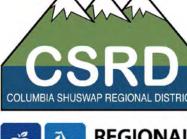
PROJECT:

## SHUSWAP NORTH OKANAGAN TRAIL 0km-3km SICAMOUS - ARMSTRONG

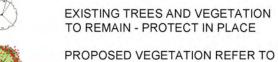LOCATION: SICAMOUS, BC










LANDSCAPE ARCHITECT



STAMP

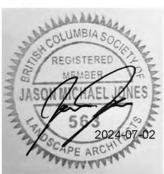

ORIGINAL SHEET SIZE ARCH D 24X36

NORTH SCALE 1:1500

ISSUED FOR: DRAFT ISSUED FOR TENDER

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**DRAWING TITLE:** REVEGETATION PLAN






REVEGATATION GUIDELINES PLAN - STATION POINTS 1+380 - 1+640 L1.2 1:500





EXISTING LOT LINES, UTILITIES, UNDERGROUND SERVICES PER CSRD DATA

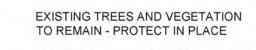

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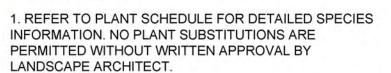
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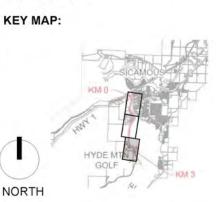
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SHUSWAP NORTH OKANAGAN TRAIL 0km-3km SICAMOUS - ARMSTRONG


LOCATION: SICAMOUS, BC

PROJECT:



CLIENTS:



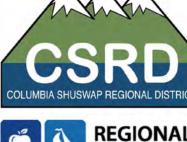




LANDSCAPE ARCHITECT



GOLDEN, BC

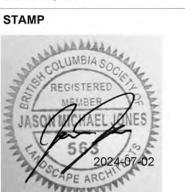

ORIGINAL SHEET SIZE ARCH D 24X36

NORTH SCALE 1:1500

ISSUED FOR: DRAFT ISSUED FOR TENDER

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DRAWING TITLE: REVEGETATION PLAN

## PLANT SCHEDULE

SYMBOL	CODE	BOTANICAL / COMMON NAME	CONT	CAL	QTY
TREES					
	BET PAP	Betula papyrifera / Paper Birch	12	60mm	8
	BET FAR	Betula platyphylla `Fargo` TM / Dakota Pinnacle Asian White Birch	7	50mm	6
The second second	POP TRE	Populus tremuloides / Trembling Aspen	-	60mm	3
SYMBOL	CODE	BOTANICAL / COMMON NAME	CONT		QTY
SHRUBS					
	ACE GLA	Acer glabrum / Rocky Mountain Maple	#5 CONT.		31
	AME SER	Amelanchier alnifolia / Saskatoon	#2 CONT.		18
	COR RE5	Cornus sericea / Red Osier Dogwood	#2 CONT.		89
No service of the ser	DES BRO	Deschampsia cespitosa `Bronzeschleier` / Tufted Hair Grass	#2 CONT.		6
	MAH AQU	Mahonia aquifolium / Oregon Grape	#2 CONT.		55
	PHI BLI	Philadelphus lewisii `Blizzard` / Blizzard Mockorange	#5 CONT.		73
	ROS NUT	Rosa nutkana / Nootka Rose	#2 CONT.		95
The state of the s	SAL PUR	Salix purpurea `Nana` / Dwarf Arctic Willow	#2 CONT.		73
0	SPI BET	Spiraea betulifolia / Birch Leaf Spirea	#5 CONT.		6
	SYM ALB	Symphoricarpos albus / Common White Snowberry	#2 CONT.		12

PROPOSED NATIVE RECLAMATION SEED MIX

TIPI MOUNTAIN NATIVE RECLAMATION GRASS SEED MIX TO BE HYDROSEEDED WITH TACKIFIER AT 200 KG/HECTARE, FERTILIZER AT 250KG/HECTARE.

ALTERNATIVE MIX OR APPROVED EQUIVALENT:

REVEGETATION MIX BY TOP CROP CRANBROOK ITEM# FRXT6108

## LEGEND



EXISTING LOT LINES, UTILITIES, UNDERGROUND SERVICES PER CSRD DATA EXISTING TREES TO REMAIN - PROTECT IN

PROPOSED VEGETATION REFER TO PLANT SCHEDULE

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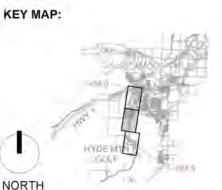
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#### PROJECT:

## SHUSWAP NORTH OKANAGAN TRAIL 0km-3km **SICAMOUS - ARMSTRONG**

LOCATION: SICAMOUS, BC












250.938.7337

GOLDEN, BC

STAMP

ORIGINAL SHEET SIZE ARCH D 24X36

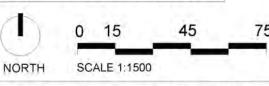

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ISSUED FOR: DRAFT ISSUED FOR TENDER

NO. DESCRIPTION.		
REVISIONS: NO. DESCRIPTION.	DATE.	BY.
1. PRELIMINARY SITE REVIEW	2022-11-02	EL/JJ
2. PRELIMINARY CONCEPT	2022-12-19	EL/JJ
3. SPLATSIN ENGAGEMENT	2023-02-03	EL/JJ
4. COMMITTEE REVIEW	2024-01-17	JJ
5. DRAFT ISSUED FOR TENDER	2024-07-02	JJ
DESIGNED BY: JJ		

DRAWING TITLE: PLANT SCHEDULE


- WATER THOROUGHLY AFTER INSTALLATION.
- INSTALL TREE STAKES IF REQUIRED BY CLIENT 3. REMOVE TREE RINGS AND STAKES TWO YEARS AFTER
- 4. DO NOT ALLOW AIR POCKETS TO FORM WHEN BACKFILLING.
- 5. POSITION CROWN OF ROOT BALL 50mm ABOVE FINISHED GRADE TO ALLOW FOR SETTLEMENT. 6. DEPTH OF ROOTBALL TO MATCH ORIGINAL ROOTBALL DEPTH

ESTABLISHED IN THE NURSERY, ANY TREES PLANTED TOO

- LOW WILL BE RAISED AT THE CONTRACTOR'S EXPENSE. DO NOT DAMAGE OR CUT LEADER. 8. IF STAKING IS DEEMED NECESSARY REFER TO TREE STAKING
- 9. DO NOT WRAP TRUNK.
- 10. INSTALL TREE GATOR WATERING SYSTEM PER MANUFACTURER SPECIFICATIONS.
- 11. ALL TREE AND SHRUB PLANTING TO MEET THE CANADIAN LANDSCAPE STANDARD SPECIFICATIONS, CURRENT EDITION.

## 1 TREE PLANTING DETAIL

L2.1 1:30

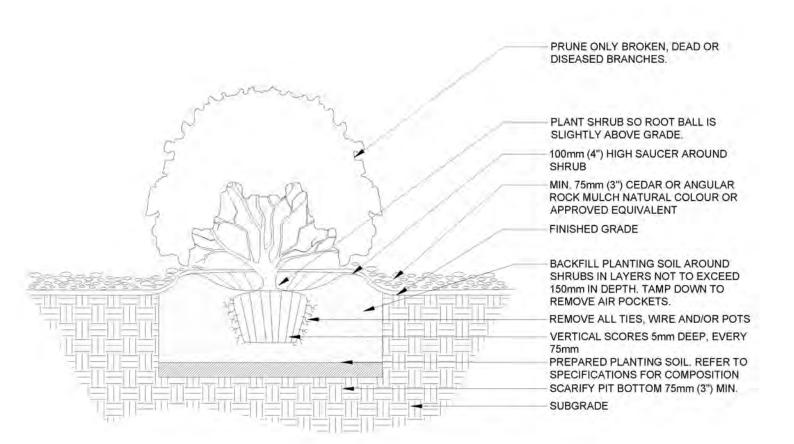

2 SHRUB PLANTING DETAIL L2.1 1:30

1. NOT TO SCALE.
2. ALL TRIGHSOMS ARE IN METIES OF UNIXES OF UNIXES.
2. STAPLE PATTERN SEE STAPLE PATTERN GUIDE FOR METIALS. EXTEND BLANKET A MINIMUM OF 0.91m OVER CREST OF SLOPE, SEE DETAIL 4. OF D.91m IS NOT AVAILABLE AT TH FLOW IS ANTICIPATED FROM UPLAND SIDE SEAM OVERLAP, BEYOND TOE OF SLOPE. FOR BOTTOM OF SLOPE TERMINATION, SEE DETAIL 3 SLOPE DETAIL END SEAM OF BLANKETS OVERLAP 0.05m-0.10m.
PLACE STAPLES, ONE ON EACH CORNER OF
BLANKET, 0.31m O.C. ALONG BLANKET END
THROUGH BOTH BLANKETS. UPSLOPE BLANKET
LAPS OVER DOWNSLOPE BLANKETS IN A SHINGLE AFFECT. 0.3m 0.C. - 0.91m MIN. STAPLES ARE THROU BOTH BLANKETS. SLOPE CREST ANCHOR
METHOD "A" (NO TRENCH) DO NOT NEED TO TRENCH BLANKET IN IF IT CAN BE EXTENDED A MINIMUM OF 0.91m OVER THE CREST OF THE SLOPE. STRAWCOCONUT - DOUBLE NET - BIODEGRADABLE COPYRIGHT 2014, TERRAFIX GEOSYNTHETICS INC. TYPICAL SLOPE APPLICATION DETAIL | 1 OF 1

BIODEGRADABLE EROSION CONTROL MATTING INFORMATION L2.1 OR APPROVED EQUIVALENT

## PRODUCT SPECIFICTIONS

## Filtrexx SiltSoxx® NATURAL ORIGINAL

PURPOSE & DESCRIPTION Filtrexx SiltSoxx NATURAL ORIGINAL is a pre-filled compost filter sock comprised of mesh material and certified FilterMedia<sup>TM</sup>. Filtrexx SiltSoxx NATURAL ORIGINAL mesh is 100% natural and biodegradable, eliminating the need for field removal. Leave in place for ongoing, natural protection.

#### APPLICATIONS Perimeter Control

- Inlet Protection
- Check Dams
- Slope Interruption

#### FOR ADDITIONAL INFORMATION Refer to the Filtrexx Catalog for full item listings.

Refer to Filtrexx Design Specifications for complete application, design, installation, maintenance, and removal documentation at www.filtrexx.com/specs

FIELD APPLICATION PHOTO REFERENCES

Filtrexx SiltSoxx NATURAL ORIGINAL used as Slope Interruption.



filtrexx

SUSTAINABLE TECHNOLOGIES

Filtrexx SiltSoxx is in compliance with most state & federal agencies including:














BIODEGRADABLE EROSION CONTROL WATTLE DETAIL L2.1

## LEGEND

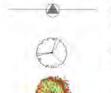

EXISTING LOT LINES, UTILITIES, UNDERGROUND SERVICES PER CSRD DATA EXISTING TREES TO REMAIN - PROTECT IN



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- 4. CONTRACTOR TO VERIFY ALL DIMENSIONS AND REPORT ANY DISCREPANCIES TO ENGINEER OR LANDSCAPE ARCHITECT. PROPERTY LINES TO BE VERIFIED PRIOR TO CONSTRUCTION.
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- 6. THE LANDSCAPE ARCHITECT WILL BE NOTIFIED MIN. 48 HOURS PRIOR TO COMMENCEMENT OF WORK.
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10. CONTRACTOR TO BE REGISTERED WITH WORKSAFE

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3. MINIMUM 150mm OF TOPSOIL AND SEED MIX TO BE PLANTED ADJACENT TO DISTURBED AREAS AND OTHER AREAS OF NEW CONSTRUCTION.

4. PLANT MATERIAL SHALL MEET ALL REQUIREMENTS OF THE LATEST EDITION OF THE CANADIAN NURSERY TRADES ASSOCIATION GUIDE SPECIFICATIONS FOR NURSERY STOCK UNLESS OTHERWISE SPECIFIED.

5. SUPPLY 75mm OF NATURAL COLOUR CEDAR BARK MULCH OR ANGULAR ROCK MULCH TO ALL PROPOSED TREE AND SHRUB BEDS.

6. INSTALL TREE GATOR BAG - SLOW RELEASE WATERING SYSTEM

(OR APPROVED EQUIVALENT) ON ALL PROPOSED DECIDUOUS TREES AND TREE GATOR JR. PRO LOW PROFILE - SLOW RELEASE WATERING SYSTEM (OR APPROVED

EQUIVALENT) ON ALL PROPOSED CONIFEROUS TREES.

6. TREES AND SHRUBS TO BE GUARANTEED FOR 1 FULL GROWING SEASONS BY CONTRACTOR. ALL REPLACEMENTS TO BE AT CONTRACTOR'S EXPENSE. SUBSTITUTIONS TO BE APPROVED BY LANDSCAPE ARCHITECT.

## **TOPSOIL NOTES:**

1. GROWING MEDIUM FOR ALL TREE, SHRUB, ANDPERENNIAL BEDS IS TO MEET THE CANADIAN LANDSCAPE SPECIFICATION UNDER THE DESIGNATION 2P.

2. GROWING MEDIUM SHOULD BE CERTIFIED TO IT'S ORIGIN AND VIRTUALLY FREE OF INVASIVE PLANT SEEDS, THEIR REPRODUCTIVE PARTS AND ROOTS BUILDING MATERIALS, INVASIVE OR NOXIOUS PLANTS, NON COMPOSTED WOOD, WOOD WASTE, INSECT PESTS, PLANT PATHOGENIC ORGANISMS, CHEMICAL POLLUTANTS OR SUBSTANCES AT LEVELS TOXIC TO PLANTS, AND OTHER EXTRANEOUS MATERIALS THAT DETRACT FROM DESIRABLE PHYSICAL AND CHEMICAL PROPERTIES REQUIRED FOR LANDSCAPING PURPOSES.

LOAM: NATURAL, FERTILE, FRIABLE, AGRICULTURAL SOIL MEETING FOLLOWING REQUIREMENTS:

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- PH VALUE RANGING FROM 5.9 TO 7.0.
- NON-TOXIC TO PLANT GROWTH. E.C.- SALINITY READING NOT EXCEEDING 1.5.
- SOIL TEXTURE: LOAM SOIL AS DEFINED BY CANADIAN SYSTEM OF SOIL CLASSIFICATION.

PEAT MOSS: DECOMPOSED PLANT MATERIAL, FAIRLY ELASTIC AND HOMOGENEOUS, FREE OF DECOMPOSED COLLOIDAL RESIDUE, WOOD, SULPHUR. AND IRON. MINIMUM OF 80% ORGANIC MATTER BY MASS; PH VALUE BETWEEN 4.5 AND 6.0.


PROJECT: SHUSWAP NORTH **OKANAGAN TRAIL 0km-3km** 

**SICAMOUS - ARMSTRONG** LOCATION:

SICAMOUS, BC





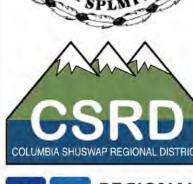



LANDSCAPE ARCHITECT



GOLDEN, BC



ORIGINAL SHEET SIZE ARCH D 24X36

NORTH SCALE 1:1500

ISSUED FOR: DRAFT ISSUED FOR TENDER DATE: 2024-07-02

NOT FOR CONSTRUCTION REVISIONS: NO. DESCRIPTION. DATE. 1. PRELIMINARY SITE REVIEW 2022-11-02 EL/JJ 2. PRELIMINARY CONCEPT 2022-12-19 EL/JJ

3. SPLATSIN ENGAGEMENT 2023-02-03 EL/JJ 4. COMMITTEE REVIEW 2024-01-17 5. DRAFT ISSUED FOR TENDER 2024-07-02 JJ DESIGNED BY: JJ

DRAWING TITLE: LANDSCAPE DETAILS

## **Shuswap North Okanagan Rail Trail**

Project #

Issued for Tender - Unit Price Schedule District of Sicamous

2024-07-02

Item / Description	Unit	Qty	Unit Cost	Total
1. CONTRACTOR USE OF SITE, SITE ACCESS, AND SITE SURVEY				
i. Contractor mobilization, establishment of site security fencing, secure staging compound, installation of stockpile areas, tree protection fencing, maintain temporary access routes, safety signage, detours, and haul roads as required. Reinstatement of all areas, surfaces and utilities disturbed. Remove construction debris and demobilization. Contractor to submit location of staging area, stockpile location and sizes, haul routes to City of Enderby representatives and Landscape Architect for approval prior to mobilization.	l.sum	1		
		•		
		Sub	-Total Section 1	
2. REVEGETATION + LANDSCAPE				
A. Trees				
i. Betula papyrifera / Paper Birch				
*Per Landscape drawings and specifications.	ea.	8		
ii. Betula platyphylla `Fargo` TM / Dakota Pinnacle Asian White Birch	ou.	•		
*Per Landscape drawings and specifications.	ea.	9		
iii. Populus tremuloides / Trembling Aspen	ca.	•		
*Per Landscape drawings and specifications.	ea.	3		

Issued for Tender - Unit Price Schedule 2024-07-02

District of Sicamous	
District of Cloarrious	

m / Description	Unit	Qty	Unit Cost	Total
B. Shrubs, Grasses, Perennials i. Acer glabrum / Rocky Mountain Maple				
*Per Landscape drawings and specifications.	ea.	34		
ii. Amelanchier alnifolia / Saskatoon	Ga.	J4 <u>-</u>		
*Per Landscape drawings and specifications.	ea.	22		
iii. Cornus sericea / Red Osier Dogwood	ca.			
*Per Landscape drawings and specifications.	ea.	95		
iv. Deschampsia cespitosa `Bronzeschleier` / Tufted Hair Grass	Ga.	95 _		
*Per Landscape drawings and specifications.	ea.	6		
v. Mahonia aquifolium / Oregon Grape	ca.	· -		
*Per Landscape drawings and specifications.	ea.	61		
vi. Philadelphus lewisii `Blizzard` / Blizzard Mockorange	ca.	O1 <u>-</u>		
*Per Landscape drawings and specifications.	ea.	80		
vii. Rosa nutka / Nutka Rose	ca.	_		
*Per Landscape drawings and specifications.	ea.	108		
viii. Salix purpurea `Nana` / Dwarf Arctic Willow	ea.	100 _		
*Per Landscape drawings and specifications.	ea.	79		
ix. Spiraea betulifolia / Birch Leaf Spirea	ea.	18 _		
*Per Landscape drawings and specifications.	ea.	6		
x. Symphoricarpos albus / Common White Snowberry	ea.	٠ -		
*Per Landscape drawings and specifications.	ea.	12		
	ca.	-		

## Shuswap North Okanagan Rail Trail

Project #

Issued for Tender - Unit Price Schedule District of Sicamous

2024-07-02

m / Descri	•	Unit	Qty	Unit Cost	Total
	cape Items			-	-
i. Feature l	Boulders				
	*Per Landscape drawings. Supply and install local source feature boulders approx. 1000mm L x 500mm H x 500mm W.	ea.	5		
ii. Tree Ga	tor Watering Bag (Deciduous Trees)	ca.	-		
	*Per Landscape drawings. Supply and install Gator Bag Pro or approved equivalent.	e.a.	17		
D. Plantin	g Medium - Topsoil		-		-
	Medium for Tree and Shrub Beds				
	*Supply and install screened topsoil to 1000mm depth per specifications including soil amendments per landscape drawings and specifications to all planting areas.	cu.m	560		
ii. Topsoil t	for reclamation areas	ou	_		
·	*Supply and install screened topsoil to 150mm depth in reclamation seed mix areas.	cu.m	430		
E. Landsc	cape Mulch	00.111	-00 _		
i. Bark Mul	<u>.</u>				
	*Supply and installation of course natural colour cedar bark or rock mulch including TYPAR landscape fabric underlay (or approved equivalent) per landscape drawings and				
	specifications.	sq.m	300		
				<b>T</b> (   <b>0</b> )	
			Sub	-Total Section 2	
				Total	
TE:					

### NOTE:

<sup>\*</sup> Contractor is to ensure all items listed above are supplied, installed, and maintained in accordance with District of Sicamous Development Guidelines & Standard Specifications and MMCD (Current Edition)

<sup>\*</sup> All quantities and areas are to be confirmed prior to construction

# SHUSWAP NORTH OKANAGAN RAIL TRAIL

BASELINE TREATMENTS FOR RAIL TRAIL RE-VEGETATION PLAN

ISSUED FOR: TENDER


## **DRAWING LIST:**

- L1.0 REVEGETATION PLAN HOT DRY RURAL AGRICULTURAL SITE
- L1.1 REVEGETATION PLAN HOT DRY RURAL AGRICULTURAL SITE
- L1.2 PLANT SCHEDULE HOT DRY RURAL AGRICULTURAL SITES
- L1.3 REVEGETATION DETAILS HOT DRY RURAL AGRICULTURAL SITES
- L2.0 REVEGETATION PLAN PROTECTION OF ARCH RESOURCES + RIPARIAN IMPROVEMENTS
- L2.1 PLANT SCHEDULE RIPARIAN IMPROVEMENTS
- L2.2 REVEGETATION DETAILS RIPARIAN IMPROVEMENTS
- L3.0 REVEGETATION PLAN SEMI-WET SITE
- L3.1 REVEGETATION PLAN SEMI-WET SITE
- L3.2 PLANT SCHEDULE - SEMI-WET SITE

2024.11.19





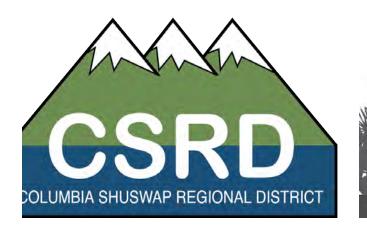





REVEGATATION GUIDELINES PLAN - BASELINE VEGETATION TREATMENTS - HOT DRY RURAL AGRICULTURAL SITE

L1.0 1:250

## LEGEND



EXISTING LOT LINES, UTILITIES, UNDERGROUND SERVICES PER CSRD DATA



EXISTING TREES AND VEGETATION TO REMAIN - PROTECT IN PLACE



PROPOSED VEGETATION REFER TO PLANT SCHEDULE

PROPOSED RECLAMATION SEED MIX AREAS
- 150mm TOPSOIL AND HYDROSEED - REFER
TO L2.0 QTY: 2,850 m2 (30,700 ft2) APPLY
TACKIFIER OR BIODEGRADABLE EROSION
CONTROL MATTING ON ANY SLOPES
EXCEEDING 3:1

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6. INSTALL TREE GATOR BAG - SLOW RELEASE WATERING SYSTEM (OR APPROVED EQUIVALENT) ON ALL PROPOSED

TREES AND TREE GATOR JR. PRO LOW PROFILE - SLOW RELEASE WATERING SYSTEM (OR APPROVED EQUIVALENT) ON

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STAMP



ORIGINAL SHEET SIZE ARCH D 24X36

0 2.5 7.5 12.5n

ISSUED FOR: TENDER

## DATE: 2024-11-19 NOT FOR CONSTRUCTION

REVISIONS: NO. DESCRIPTION.	DATE.	BY.
1. SPLATSIN ENGAGEMENT	2023-02-03	EL/Ju
2. COMMITTEE REVIEW	2024-07-30	JJ
3. ISSUED FOR TENDER	2024-11-19	JJ

DESIGNED BY: JJ

REVEGETATION PLAN
HOT DRY AGRICULTURAL
BASELINE CONCEPT

L-1.0




L1.1 / 1:250


## LEGEND




EXISTING LOT LINES, UTILITIES, UNDERGROUND SERVICES PER CSRD DATA

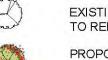

EXISTING TREES AND VEGETATION TO REMAIN - PROTECT IN PLACE

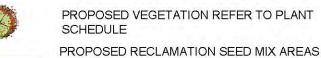

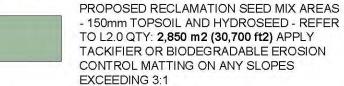

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PROJECT:

## SHUSWAP NORTH OKANAGAN RAIL TRAIL BASELINE TREATMENTS


LOCATION: SICAMOUS - ENDERBY, BC



CLIENTS:

NORTH



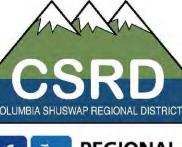



LANDSCAPE ARCHITECT





ORIGINAL SHEET SIZE ARCH D 24X36

NORTH SCALE 1:250

ISSUED FOR: TENDER

DATE: 2024-11-19

## NOT FOR CONSTRUCTION

NO. DESCRIPTION. DATE. BY. 1. SPLATSIN ENGAGEMENT 2023-02-03 EL/JJ 2. COMMITTEE REVIEW 2024-07-30 JJ 3. ISSUED FOR TENDER 2024-11-19 JJ

DESIGNED BY: JJ

**DRAWING TITLE: REVEGETATION PLAN** HOT DRY AGRICULTURAL

**BASELINE CONCEPT** 

## PLANT SCHEDULE HOT DRY PLANT TYPOLOGY PER 500 - 1000 METERS

SYMBOL	CODE	BOTANICAL / COMMON NAME	CONT	CAL	SIZE	QTY
TREES						
	BET PAP	Betula papyrifera / Paper Birch	Ģ.	60mm		1
X	FRA PRA	Fraxinus pennsylvanica 'Prairie Spire' / Prairie Spire Ash	- -	60mm		9
$\left\langle \mathbf{x}\right\rangle$	MAL HON	Malus domestica / Apple	ż.	50mm		2
	PIN PON	Pinus ponderosa / Ponderosa Pine	3)		2.0m HT.	3
	POP SAR	Populus sargentii / Plains Cottonwood	2	60mm		3
	POP TRE	Populus tremuloides / Trembling Aspen		60mm		9
	PRU SPP	Prunus domestica / Local Variety Plum	20	50mm		t
SYMBOL	CODE	BOTANICAL / COMMON NAME	CONT			QTY
SHRUBS						
	ACE GLA	Acer glabrum / Rocky Mountain Maple	#5 CONT.			5
0	AME SER	Amelanchier alnifolia / Saskatoon	#2 CONT.			10
0	COR RE5	Cornus sericea / Red Osier Dogwood	#2 CONT.			9
	MAH AQU	Mahonia aquifolium / Oregon Grape	#2 CONT.			14
	PHI BLI	Philadelphus lewisii `Blizzard` / Blizzard Mockorange	#5 CONT.			6
0	PHY COP	Physocarpus opulifolius / Indigenous Ninebark	#5 CONT.			5
	ROS COM	Rosa acicularis / Prickly Rose	#2 CONT.			3
0	ROS NUT	Rosa nutkana / Nootka Rose	#2 CONT.			9
	SAL PUR	Salix purpurea `Nana` / Dwarf Arctic Willow	#2 CONT.			5
	SHE ARG	Shepherdia argentea / Silver Buffaloberry	#2 CONT.			5
	VIB AM2	Viburnum trilobum / Indigenous Highbush Cranberrybush	#2 CONT.			2




TIPI MOUNTAIN NATIVE RECLAMATION GRASS SEED MIX TO BE HYDROSEEDED WITH TACKIFIER AT 200 KG/HECTARE, FERTILIZER AT 250KG/HECTARE.

ALTERNATIVE MIX OR APPROVED EQUIVALENT:


REVEGETATION MIX BY TOP CROP CRANBROOK ITEM# FRXT6108

### LEGEND

EXISTING LOT LINES, UTILITIES, UNDERGROUND SERVICES PER CSRD DATA EXISTING TREES AND VEGETATION

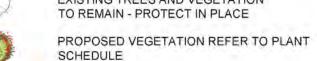

SCHEDULE

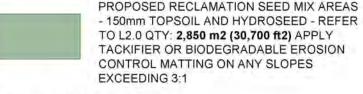

#### **GENERAL NOTES:**

- 1. CONTRACTOR TO LOCATE AND PROTECT ALL EXISTING UTILITIES AND SERVICES, BC ONE CALL 1-800-474-6886.
- 2. ALL WORK AND MATERIALS ARE TO BE IN ACCORDANCE WITH THE CURRENT EDITIONS OF THE CITY OF SICAMOUS CONSTRUCTION STANDARDS, AND THE MASTER MUNICIPAL CONSTRUCTION DOCUMENTS (MMCD) REQUIREMENTS.
- 3. CONTRACTOR SHALL VERIFY SITE CONDITIONS PRIOR TO DEMOLITION OR CONSTRUCTION.
- 4. CONTRACTOR TO VERIFY ALL DIMENSIONS AND REPORT ANY DISCREPANCIES TO ENGINEER OR LANDSCAPE ARCHITECT. PROPERTY LINES TO BE VERIFIED PRIOR TO CONSTRUCTION.
- 5. CONTRACTOR IS RESPONSIBLE TO COORDINATE THE STAGING OF CONSTRUCTION ACTIVITIES AND WORK WITH ALL OTHER CONTRACTORS ONSITE, INCLUDING SLEEVING AND WEEPING TILE DOWNSPOUT LOCATIONS PRIOR TO HARDSCAPE /SOFTSCAPE INSTALLATION.
- 6. THE LANDSCAPE ARCHITECT WILL BE NOTIFIED MIN. 48 HOURS PRIOR TO COMMENCEMENT OF WORK.
- 7. THE QUANTITIES LISTED ARE ESTIMATES. CONTRACTOR TO VERIFY ALL QUANTITIES THROUGH SITE SURVEY AND REPORT ANY DISCREPANCIES TO ENGINEER OR LANDSCAPE ARCHITECT.
- 8. ANY CHANGES OR ALTERATIONS TO DRAWINGS SHALL BE APPROVED BY LANDSCAPE ARCHITECT.
- 9. CONTRACTOR TO CONFIRM ELEVATION, LOCATION, AND GRADIENT OF SURROUNDING GRADES AND PROVIDE A SMOOTH TRANSITION.
- 10. CONTRACTOR TO BE REGISTERED WITH WORKSAFE BC.

### PLANTING NOTES:

1. REFER TO PLANT SCHEDULE FOR DETAILED SPECIES INFORMATION. NO PLANT SUBSTITUTIONS ARE PERMITTED WITHOUT WRITTEN APPROVAL BY LANDSCAPE ARCHITECT.

2. CONFINE EQUIPMENT AND WORKERS TO LIMIT OF DISTURBANCE WITHIN PROJECT BOUNDARY.

3. MINIMUM 150mm OF TOPSOIL AND SEED MIX TO BE PLANTED ADJACENT TO DISTURBED AREAS AND OTHER AREAS OF NEW CONSTRUCTION.

4. PLANT MATERIAL SHALL MEET ALL REQUIREMENTS OF THE LATEST EDITION OF THE CANADIAN NURSERY TRADES ASSOCIATION GUIDE SPECIFICATIONS FOR NURSERY STOCK UNLESS OTHERWISE SPECIFIED.

5. SUPPLY 75mm OF NATURAL COLOUR CEDAR BARK MULCH OR ANGULAR ROCK MULCH TO ALL PROPOSED TREE AND SHRUB BEDS.

6. INSTALL TREE GATOR BAG - SLOW RELEASE WATERING SYSTEM (OR APPROVED EQUIVALENT) ON ALL PROPOSED

TREES AND TREE GATOR JR. PRO LOW PROFILE - SLOW RELEASE WATERING SYSTEM (OR APPROVED EQUIVALENT) ON

ALL PROPOSED CONIFEROUS TREES.

6. TREES AND SHRUBS TO BE GUARANTEED FOR 1 FULL GROWING SEASONS BY CONTRACTOR. ALL REPLACEMENTS TO BE AT CONTRACTOR'S EXPENSE. SUBSTITUTIONS TO BE APPROVED BY LANDSCAPE ARCHITECT.

## TOPSOIL NOTES:

1. GROWING MEDIUM FOR ALL TREE, SHRUB, ANDPERENNIAL BEDS IS TO MEET THE CANADIAN LANDSCAPE SPECIFICATION UNDER THE DESIGNATION 2P.

2. GROWING MEDIUM SHOULD BE CERTIFIED TO IT'S ORIGIN AND VIRTUALLY FREE OF INVASIVE PLANT SEEDS, THEIR REPRODUCTIVE PARTS AND ROOTS, BUILDING MATERIALS, INVASIVE OR NOXIOUS PLANTS, NON COMPOSTED WOOD, WOOD WASTE, INSECT PESTS, PLANT PATHOGENIC ORGANISMS, CHEMICAL POLLUTANTS OR SUBSTANCES AT LEVELS TOXIC TO PLANTS, AND OTHER EXTRANEOUS MATERIALS THAT DETRACT FROM DESIRABLE PHYSICAL AND CHEMICAL PROPERTIES REQUIRED FOR LANDSCAPING PURPOSES.

LOAM: NATURAL, FERTILE, FRIABLE, AGRICULTURAL

- SOIL MEETING FOLLOWING REQUIREMENTS: NOT LESS THAN 6% ORGANIC MATERIAL.
- PH VALUE RANGING FROM 5.9 TO 7.0.
- NON-TOXIC TO PLANT GROWTH. E.C.- SALINITY READING NOT EXCEEDING 1.5. SOIL TEXTURE: LOAM SOIL AS DEFINED BY
- CANADIAN SYSTEM OF SOIL CLASSIFICATION.

PEAT MOSS: DECOMPOSED PLANT MATERIAL, FAIRLY ELASTIC AND HOMOGENEOUS, FREE OF DECOMPOSED COLLOIDAL RESIDUE, WOOD, SULPHUR, AND IRON, MINIMUM OF 80% ORGANIC MATTER BY MASS; PH VALUE BETWEEN 4.5 AND 6.0.

#### PROJECT:

KEY MAP:

## SHUSWAP NORTH OKANAGAN RAIL TRAIL **BASELINE TREATMENTS**

LOCATION: SICAMOUS - ENDERBY, BC

SICAMOUS

NORTH







LANDSCAPE ARCHITECT



GOLDEN, BC



ORIGINAL SHEET SIZE ARCH D 24X36

0 2.5 7.5 12.5m NORTH SCALE 1:250

ISSUED FOR: TENDER

## DATE: 2024-11-19 NOT FOR CONSTRUCTION

REVISIONS: NO. DESCRIPTION:	DATE.	BY.
1. SPLATSIN ENGAGEMENT	2023-02-03	EL/JJ
2. COMMITTEE REVIEW	2024-07-30	ĴĴ
3. ISSUED FOR TENDER	2024-11-19	JJ

DESIGNED BY: JJ


DRAWING TITLE: REVEGETATION PLAN HOT DRY AGRICULTURAL PLANT TYPOLOGY

- WATER THOROUGHLY AFTER INSTALLATION.
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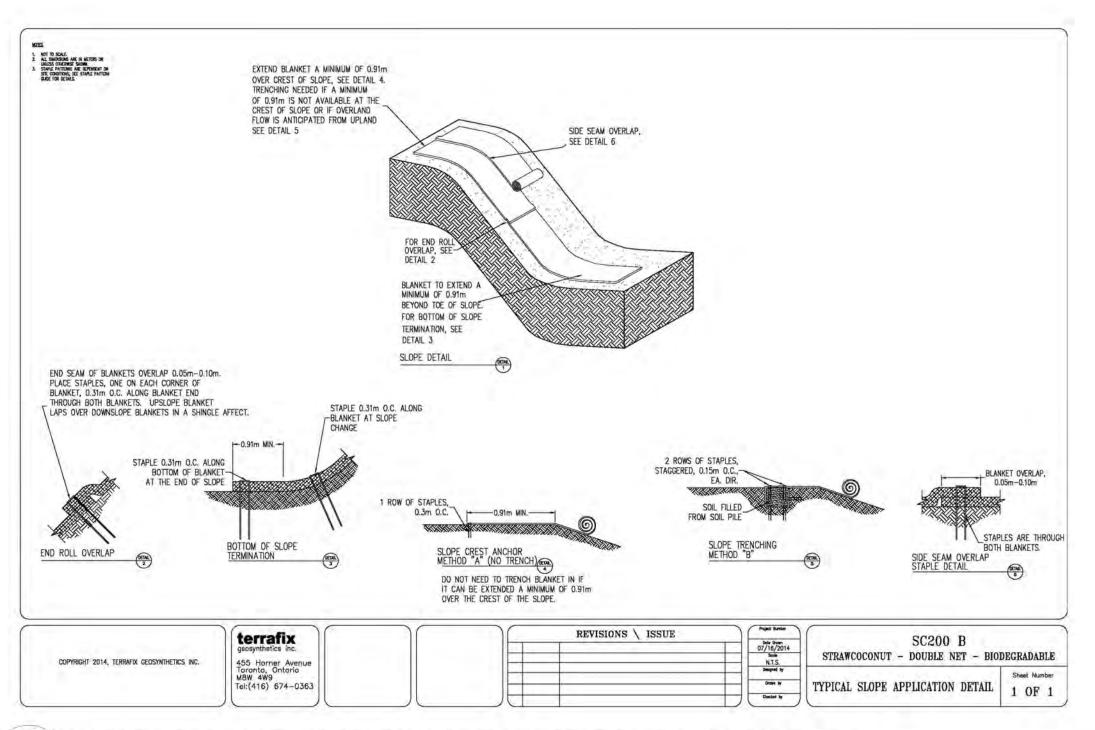
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## 1 TREE PLANTING DETAIL L1.3 1:30



2 SHRUB PLANTING DETAIL L1.3 1:30

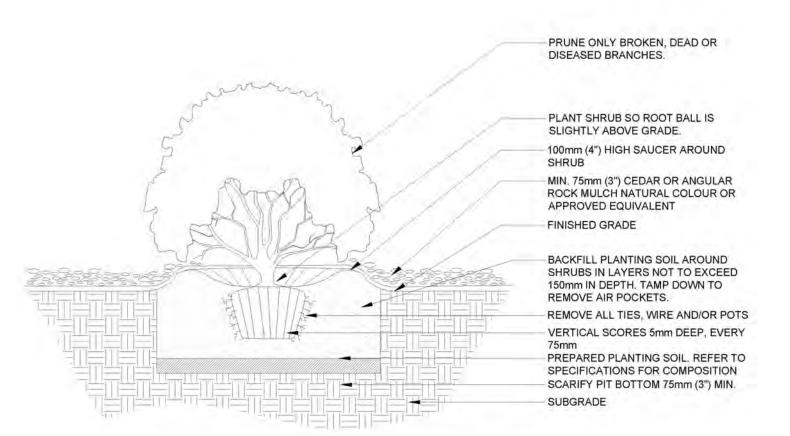

BIODEGRADABLE EROSION CONTROL MATTING INFORMATION 113 OR APPROVED EQUIVALENT

## PRODUCT SPECIFICTIONS

## Filtrexx SiltSoxx® NATURAL ORIGINAL

PURPOSE & DESCRIPTION Filtrexx SiltSoxx NATURAL ORIGINAL is a pre-filled compost filter sock comprised of mesh material and certified FilterMedia<sup>TM</sup>. Filtrexx SiltSoxx NATURAL ORIGINAL mesh is 100% natural and biodegradable, eliminating the need for field removal. Leave in place for ongoing, natural protection.

#### APPLICATIONS Perimeter Control

- · Inlet Protection
- Check Dams
- Slope Interruption

#### FOR ADDITIONAL INFORMATION Refer to the Filtrexx Catalog for full item listings.

Refer to Filtrexx Design Specifications for complete application, design, installation, maintenance, and removal documentation at www.filtrexx.com/specs

FIELD APPLICATION PHOTO REFERENCES

Filtrexx SiltSoxx NATURAL ORIGINAL used as Slope Interruption:



filtrexx

SUSTAINABLE TECHNOLOGIES

Filtrexx SiltSoxx is in compliance with most state & federal agencies including:












BIODEGRADABLE EROSION CONTROL WATTLE DETAIL L1.3

## LEGEND

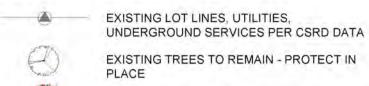



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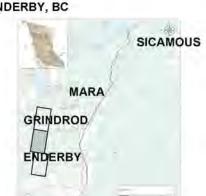
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PROJECT: SHUSWAP NORTH


## **OKANAGAN RAIL TRAIL BASELINE TREATMENTS**

LOCATION: SICAMOUS - ENDERBY, BC

KEY MAP:



NORTH CLIENTS: TOGETHER TOWARD

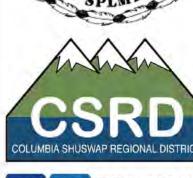




LANDSCAPE ARCHITECT



GOLDEN, BC



ORIGINAL SHEET SIZE ARCH D 24X36

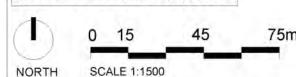

ISSUED FOR: TENDER

## DATE: 2024-11-19 NOT FOR CONSTRUCTION

REVISIONS: NO. DESCRIPTION. DATE. 1. SPLATSIN ENGAGEMENT 2023-02-03 2. COMMITTEE REVIEW 2024-07-30 3. ISSUED FOR TENDER 2024-11-19 JJ

DESIGNED BY: JJ

DRAWING TITLE: LANDSCAPE DETAILS



REVEGATATION GUIDELINES PLAN - BASELINE CONCEPT - PROTECTION OF ARCHEOLOGICAL RESOURCES + RIPARIAN IMPROVEMENT EXAMPLE

L2.0 1:250

## LEGEND

EXISTING LOT LINES, UTILITIES, UNDERGROUND SERVICES PER CSRD DATA



EXISTING TREES AND VEGETATION TO REMAIN - PROTECT IN PLACE



PROPOSED VEGETATION REFER TO PLANT SCHEDULE PROPOSED RECLAMATION/RIPARIAN SEED MIX AREAS - 150mm TOPSOIL AND

MATTING ON ANY SLOPES EXCEEDING 3:1



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PROJECT:

## SHUSWAP NORTH **OKANAGAN RAIL TRAIL BASELINE TREATMENTS**

LOCATION: SICAMOUS - ENDERBY, BC



NORTH










GOLDEN, BC

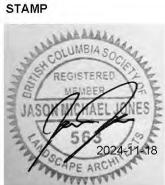

ORIGINAL SHEET SIZE ARCH D 24X36

NORTH SCALE 1:250

ISSUED FOR: TENDER

DATE: 2024-11-19 NOT FOR CONSTRUCTION

NO. DESCRIPTION. DATE. 1. SPLATSIN ENGAGEMENT 2023-02-03 EL/JJ 2. COMMITTEE REVIEW 2024-07-30 JJ 3. ISSUED FOR TENDER 2024-11-19 JJ


DESIGNED BY: JJ

DRAWING TITLE : **REVEGETATION PLAN** PROTECTION OF ARCH RESOURCES

- 1. WATER THOROUGHLY AFTER INSTALLATION.
- INSTALL TREE STAKES IF REQUIRED BY CLIENT 3. REMOVE TREE RINGS AND STAKES TWO YEARS AFTER
- 4. DO NOT ALLOW AIR POCKETS TO FORM WHEN BACKFILLING.
- 5. POSITION CROWN OF ROOT BALL 50mm ABOVE FINISHED GRADE TO ALLOW FOR SETTLEMENT.
- 6. DEPTH OF ROOTBALL TO MATCH ORIGINAL ROOTBALL DEPTH ESTABLISHED IN THE NURSERY. ANY TREES PLANTED TOO LOW WILL BE RAISED AT THE CONTRACTOR'S EXPENSE.
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- 9. DO NOT WRAP TRUNK.
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- LANDSCAPE STANDARD SPECIFICATIONS, CURRENT EDITION.

# TREE PLANTING DETAIL

L2.1 1:30

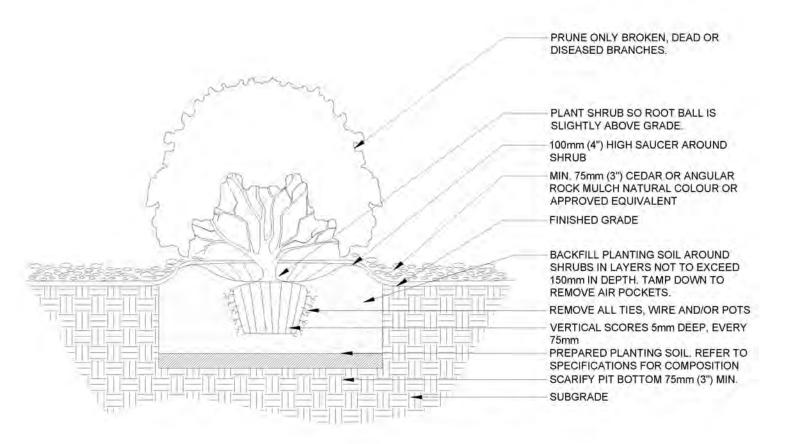

# 2 SHRUB PLANTING DETAIL

1:30

# PLANT SCHEDULE RIPARIAN PROTECTION PER 500 - 1000 METERS

SYMBOL	CODE	BOTANICAL / COMMON NAME	CONT	CAL	SIZE	QTY	
TREES							
	BET PAP	Betula papyrifera / Paper Birch	¥	60mm		4	
	PIN PON	Pinus ponderosa / Ponderosa Pine	W.		2.0m HT.	1	
	POP TRE	Populus tremuloides / Trembling Aspen		60mm		3	
0	POP TRI	Populus trichocarpa / Black Cottonwood	2.0m HT.			4	
SYMBOL	CODE	BOTANICAL / COMMON NAME	CONT			QTY	
SHRUBS	ACE GLA	Acer glabrum / Rocky Mountain Maple	#5 CONT.			5	
0	AME SER	Amelanchier alnifolia / Saskatoon	#2 CONT.			18	
0	COR RE5	Cornus sericea / Red Osier Dogwood	#2 CONT.			12	
*	OPL HOR	Oplopanax horridus / Devil's Club	#2 CONT.			26	*ONLY FOR ARCH. PROTECTION
	PHI BLI	Philadelphus lewisii `Blizzard` / Blizzard Mockorange	#5 CONT.			3	
*	RIB OXY	Ribes oxycanthoides / Northern Gooseberry	#2 CONT.			17	*ONLY FOR ARCH. PROTECTION
	ROS COM	Rosa acicularis / Prickly Rose	#2 CONT.			11	
	SAL PUR	Salix purpurea `Nana` / Dwarf Arctic Willow	#2 CONT.			9	
	SHE ARG	Shepherdia argentea / Silver Buffaloberry	#2 CONT.			3	
	VIB AM2	Viburnum trilobum / Indigenous Highbush Cranberrybush	#2 CONT.			3	

# PROPOSED NATIVE RECLAMATION SEED MIX

TIPI MOUNTAIN NATIVE RECLAMATION GRASS SEED MIX TO BE HYDROSEEDED WITH TACKIFIER AT 200 KG/HECTARE, FERTILIZER AT 250KG/HECTARE.

ALTERNATIVE MIX OR APPROVED EQUIVALENT:

REVEGETATION MIX BY TOP CROP CRANBROOK ITEM# FRXT6108

# PROPOSED NATIVE RIPARIAN SEED MIX WITH LIVE STAKING

- SOURCE LIVE STAKES AS LOCALLY AS POSSIBLE.
- LIVE STAKES MUST BE HARVESTED AND PLANTED DURING DORMANT PERIOD (OCTOBER -MARCH).
- MAKE PILOT HOLE IN GROUND USING IRON STAKE OR BAR BEFORE PLANTING LIVE STAKE.
- PLANT STAKES WITH BUTT END IN GROUND AND BUDS OR LEAF BUD SCARS POINTING UP.
- TAKE CARE NOT TO DAMAGE BUDS, STRIP BARK OR SPLIT STAKE DURING PLANTING.
- STAKES SHALL BE SPACED RANDOMLY AT A MINIMUM RATE OF 6 STAKES PER m2 IN AREAS IDENTIFIED AS APPROPRIATE.
- STAKES SHALL BE 300MM (12") IN LENGTH AND EMBEDDED TO 80% OF STAKE LENGTH.
- AT LEAST 2 BUDS AND/OR LEAF BUD SCARS SHALL BE VISIBLE ABOVE GROUND AFTER PLANTING.
- TRIM STAKE MAKING A DIAGONAL CUT AT TOP OF STAKE JUST ABOVE TOP BUD AND A HORIZONTAL CUT AT BOTTOM OF STAKE JUST BELOW BOTTOM BUD.

# LEGEND

EXISTING LOT LINES, UTILITIES, UNDERGROUND SERVICES PER CSRD DATA EXISTING TREES AND VEGETATION TO REMAIN - PROTECT IN PLACE

SCHEDULE

PROPOSED VEGETATION REFER TO PLANT

PROPOSED RECLAMATION/RIPARIAN SEED MIX AREAS - 150mm TOPSOIL AND HYDROSEED - APPLY TACKIFIER OR BIODEGRADABLE EROSION CONTROL MATTING ON ANY SLOPES EXCEEDING 3:1

# **GENERAL NOTES:**

- 1. CONTRACTOR TO LOCATE AND PROTECT ALL EXISTING UTILITIES AND SERVICES, BC ONE CALL 1-800-474-6886.
- 2. ALL WORK AND MATERIALS ARE TO BE IN ACCORDANCE WITH THE CURRENT EDITIONS OF THE CITY OF SICAMOUS CONSTRUCTION STANDARDS, AND THE MASTER MUNICIPAL CONSTRUCTION DOCUMENTS (MMCD) REQUIREMENTS.
- 3. CONTRACTOR SHALL VERIFY SITE CONDITIONS PRIOR TO DEMOLITION OR CONSTRUCTION.
- 4. CONTRACTOR TO VERIFY ALL DIMENSIONS AND REPORT ANY DISCREPANCIES TO ENGINEER OR LANDSCAPE ARCHITECT. PROPERTY LINES TO BE VERIFIED PRIOR TO CONSTRUCTION.
- 5. CONTRACTOR IS RESPONSIBLE TO COORDINATE THE STAGING OF CONSTRUCTION ACTIVITIES AND WORK WITH ALL OTHER CONTRACTORS ONSITE, INCLUDING SLEEVING AND WEEPING TILE DOWNSPOUT LOCATIONS PRIOR TO HARDSCAPE /SOFTSCAPE INSTALLATION.
- 6. THE LANDSCAPE ARCHITECT WILL BE NOTIFIED MIN. 48 HOURS PRIOR TO COMMENCEMENT OF WORK.
- 7. THE QUANTITIES LISTED ARE ESTIMATES. CONTRACTOR TO VERIFY ALL QUANTITIES THROUGH SITE SURVEY AND REPORT ANY DISCREPANCIES TO ENGINEER OR LANDSCAPE ARCHITECT.
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- 9. CONTRACTOR TO CONFIRM ELEVATION, LOCATION, AND GRADIENT OF SURROUNDING GRADES AND PROVIDE A SMOOTH TRANSITION.
- 10. CONTRACTOR TO BE REGISTERED WITH WORKSAFE BC.

# PLANTING NOTES:

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2. CONFINE EQUIPMENT AND WORKERS TO LIMIT OF DISTURBANCE WITHIN PROJECT BOUNDARY.

3. MINIMUM 150mm OF TOPSOIL AND SEED MIX TO BE PLANTED ADJACENT TO DISTURBED AREAS AND OTHER AREAS OF NEW CONSTRUCTION.

4. PLANT MATERIAL SHALL MEET ALL REQUIREMENTS OF THE LATEST EDITION OF THE CANADIAN NURSERY TRADES ASSOCIATION GUIDE SPECIFICATIONS FOR NURSERY STOCK UNLESS OTHERWISE SPECIFIED.

5. SUPPLY 75mm OF NATURAL COLOUR CEDAR BARK MULCH OR ANGULAR ROCK MULCH TO ALL PROPOSED TREE AND SHRUB BEDS.

6. INSTALL TREE GATOR BAG - SLOW RELEASE WATERING SYSTEM (OR APPROVED EQUIVALENT) ON ALL PROPOSED TREES AND TREE GATOR JR. PRO LOW PROFILE - SLOW RELEASE WATERING SYSTEM (OR APPROVED

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# TOPSOIL NOTES:

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LOAM: NATURAL, FERTILE, FRIABLE, AGRICULTURAL

- SOIL MEETING FOLLOWING REQUIREMENTS: NOT LESS THAN 6% ORGANIC MATERIAL.
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- NON-TOXIC TO PLANT GROWTH.
- E.C.- SALINITY READING NOT EXCEEDING 1.5. SOIL TEXTURE: LOAM SOIL AS DEFINED BY
- PEAT MOSS: DECOMPOSED PLANT MATERIAL, FAIRLY

CANADIAN SYSTEM OF SOIL CLASSIFICATION.

ELASTIC AND HOMOGENEOUS, FREE OF DECOMPOSED COLLOIDAL RESIDUE, WOOD, SULPHUR, AND IRON. MINIMUM OF 80% ORGANIC MATTER BY MASS; PH VALUE BETWEEN 4.5 AND 6.0.

# PROJECT:

KEY MAP:

# SHUSWAP NORTH OKANAGAN RAIL TRAIL **BASELINE TREATMENTS**

LOCATION: SICAMOUS - ENDERBY, BC



ENDERBY

NORTH CLIENTS:







LANDSCAPE ARCHITECT



GOLDEN, BC



ORIGINAL SHEET SIZE ARCH D 24X36

12.5m NORTH SCALE 1:250

ISSUED FOR: TENDER

# DATE: 2024-11-19 NOT FOR CONSTRUCTION

REVISIONS: NO. DESCRIPTION. DATE. 1. SPLATSIN ENGAGEMENT 2023-02-03 2. COMMITTEE REVIEW 2024-07-30 3. ISSUED FOR TENDER 2024-11-19 JJ

DESIGNED BY: JJ

DRAWING TITLE : REVEGETATION PLAN **ARCH + RIPARIAN** RESOURCES

- LIVE STAKES MUST BE HARVESTED AND PLANTED DURING DORMANT PERIOD (OCTOBER - MARCH).
- SOURCE AS LOCALLY AS POSSIBLE.
- 3. MAKE PILOT HOLE IN GROUND USING IRON STAKE OR BAR BEFORE PLANTING WILLOW STAKE.
- 4. PLANT STAKES WITH BUTT END IN GROUND AND BUDS OR LEAF BUD SCARS POINTING UP.
- TAKE CARE NOT TO DAMAGE BUDS, STRIP BARK OR SPLIT STAKE DURING PLANTING.
- 6. STAKES SHALL BE SPACED RANDOMLY AT A MINIMUM RATE OF 6 STAKES PER m2.
- 7. STAKES SHALL BE 300mm (12") IN LENGTH AND EMBEDDED TO 80% OF STAKE LENGTH.
- 7. AT LEAST 2 BUDS AND/OR LEAF BUD SCARS SHALL BE VISIBLE ABOVE GROUND AFTER PLANTING.

OF STAKE JUST BELOW BOTTOM BUD.

8. TRIM STAKE MAKING A DIAGONAL CUT AT TOP OF STAKE JUST ABOVE TOP BUD AND A HORIZONTAL CUT AT BOTTOM





Product Name

Tensile Strength (ASTM D4595)<sup>2</sup>

Fill Material


Mesh Color

FilterMedia Sample

TechLink #3342 for full tensile strength testing.



# 1 LIVE STAKING DETAIL L2.2 1:30

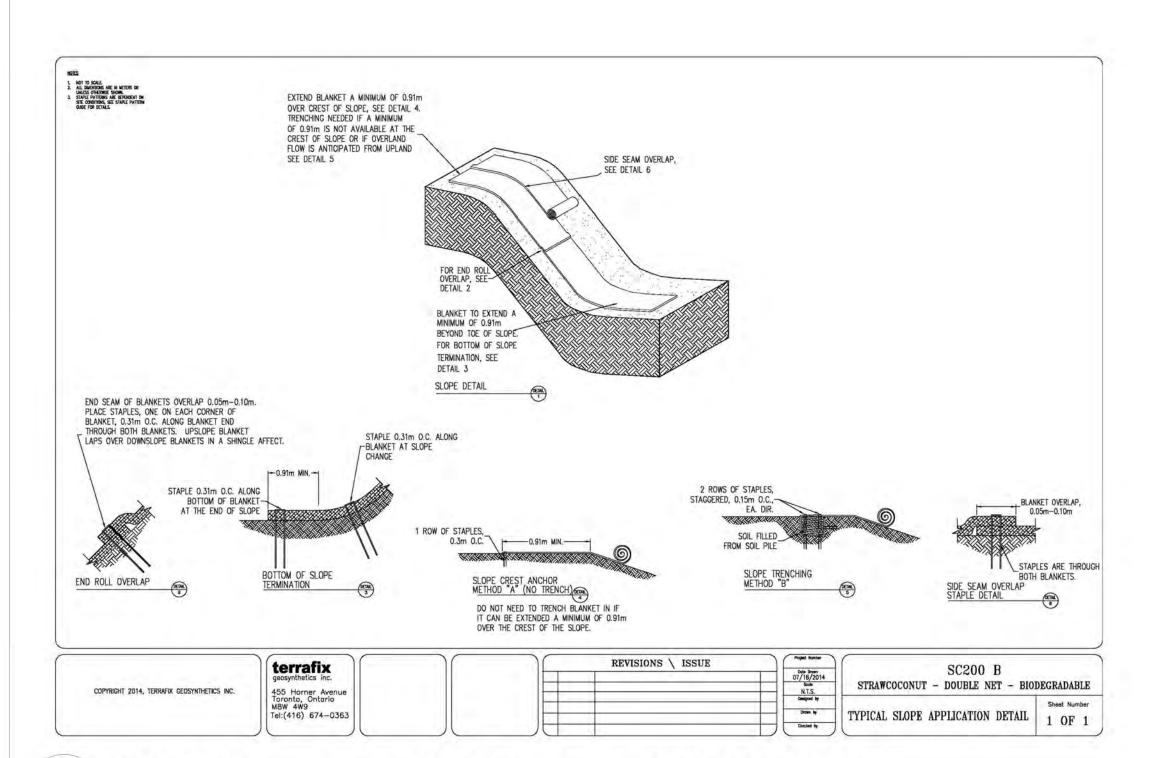

# 2 BIODEGRADABLE EROSION CONTROL MATTING INFORMATION L2.2 OR APPROVED EQUIVALENT

# PRODUCT SPECIFICTIONS

# Filtrexx SiltSoxx® NATURAL ORIGINAL

PURPOSE & DESCRIPTION Filtrexx SiltSoxx NATURAL ORIGINAL is a pre-filled compost filter sock comprised of mesh material and certified FilterMedia™. Filtrexx SiltSoxx NATURAL ORIGINAL mesh is 100% natural and biodegradable, eliminating the need for field removal. Leave in place for ongoing, natural protection.

- APPLICATIONS Perimeter Control
- · Inlet Protection
- Check Dams Slope Interruption

FOR ADDITIONAL INFORMATION Refer to the Filtrexx Catalog for full item listings.

Refer to Filtrexx Design Specifications for complete application, design, installation, maintenance, and removal documentation at www.filtrexx.com/specs

FIELD APPLICATION PHOTO REFERENCES

Filtrexx SiltSoxx NATURAL ORIGINAL used as Slope Interruption.

Filtrexx SiltSoxx is in compliance with most state & federal agencies including:

# filtrexx

up to 12 mo

MD: 193 lbs

TD: 158 lbs

Functional longevity ranges are estimates only. Site specific environmental conditions may result in significantly shorter or longer time periods.

Tensile Strength is based on 12\* diameter using ATSM D4595. See Filtrexa

Locally sourced FilterMedia

USDA CERTIFIED BIOBASED PRODUCT

SUSTAINABLE TECHNOLOGIES

Filtrexx SiltSoxx NATURAL ORIGINAL Specifications WATERING SYSTEM Filtrexx SiltSoxx (OR APPROVED EQUIVALENT) ON ALL PROPOSED NATURAL ORIGINAL DECIDUOUS All Natural Mesh Material Type Biodegradable Cotton Fiber EQUIVALENT) ON leave on site; short-term ALL PROPOSED CONIFEROUS TREES. Mesh Opening Size 5", 8", 12" GROWING SEASONS BY CONTRACTOR. ALL

REPLACEMENTS TO BE AT CONTRACTOR'S EXPENSE. SUBSTITUTIONS TO BE APPROVED BY LANDSCAPE ARCHITECT.

# **TOPSOIL NOTES:**

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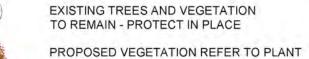
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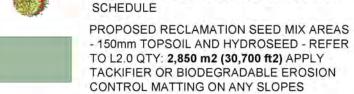
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# LEGEND



EXISTING LOT LINES, UTILITIES, UNDERGROUND SERVICES PER CSRD DATA





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EXCEEDING 3:1

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TREES AND TREE GATOR JR. PRO LOW PROFILE - SLOW RELEASE WATERING SYSTEM (OR APPROVED

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KEY MAP:


# SHUSWAP NORTH **OKANAGAN RAIL TRAIL BASELINE TREATMENTS**

LOCATION: SICAMOUS - ENDERBY, BC



ENDERBY NORTH



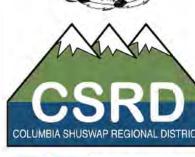



LANDSCAPE ARCHITECT



GOLDEN, BC



ORIGINAL SHEET SIZE ARCH D 24X36

12.5m NORTH SCALE 1:250

ISSUED FOR: TENDER

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2. COMMITTEE REVIEW	2024-07-30	JJ
3. ISSUED FOR TENDER	2024-11-19	JJ

DESIGNED BY: JJ

DRAWING TITLE : REVEGETATION PLAN LANDSCAPE DETAILS



BIODEGRADABLE EROSION CONTROL WATTLE DETAIL




REVEGATATION GUIDELINES PLAN - BASELINE CONCEPT - SEMI-WET SEASONALLY INUNDATED SITES

L3.0 1:250


# LEGEND




EXISTING LOT LINES, UTILITIES, UNDERGROUND SERVICES PER CSRD DATA

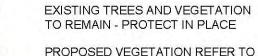

TO REMAIN - PROTECT IN PLACE

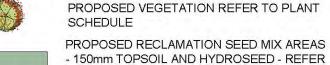

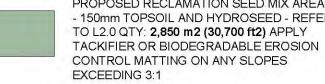

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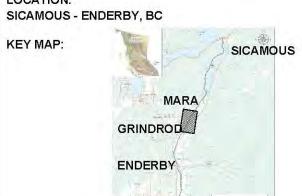
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PROJECT:

# SHUSWAP NORTH OKANAGAN RAIL TRAIL BASELINE TREATMENTS

LOCATION: SICAMOUS - ENDERBY, BC



CLIENTS:



CSRD COLUMBIA SHUSWAP REGIONAL DISTRICT





GOLDEN, BC



ORIGINAL SHEET SIZE ARCH D 24X36

NORTH SCALE 1:250

ISSUED FOR: TENDER

DATE: 2024-11-19 NOT FOR CONSTRUCTION

NO. DESCRIPTION. DATE. BY. 1. SPLATSIN ENGAGEMENT 2023-02-03 EL/JJ 2. COMMITTEE REVIEW 2024-07-30 JJ 3. ISSUED FOR TENDER 2024-11-19 JJ

DESIGNED BY: JJ

DRAWING TITLE: **REVEGETATION PLAN** SEMI-WET SITES

L-3.0





# LEGEND

EXISTING LOT LINES, UTILITIES, UNDERGROUND SERVICES PER CSRD DATA



EXISTING TREES AND VEGETATION TO REMAIN - PROTECT IN PLACE

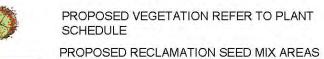

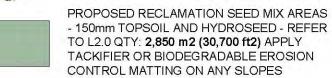

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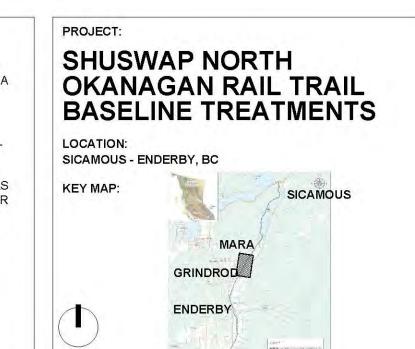
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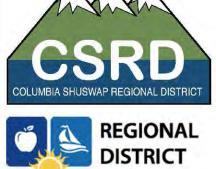
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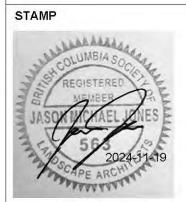








GOLDEN, BC



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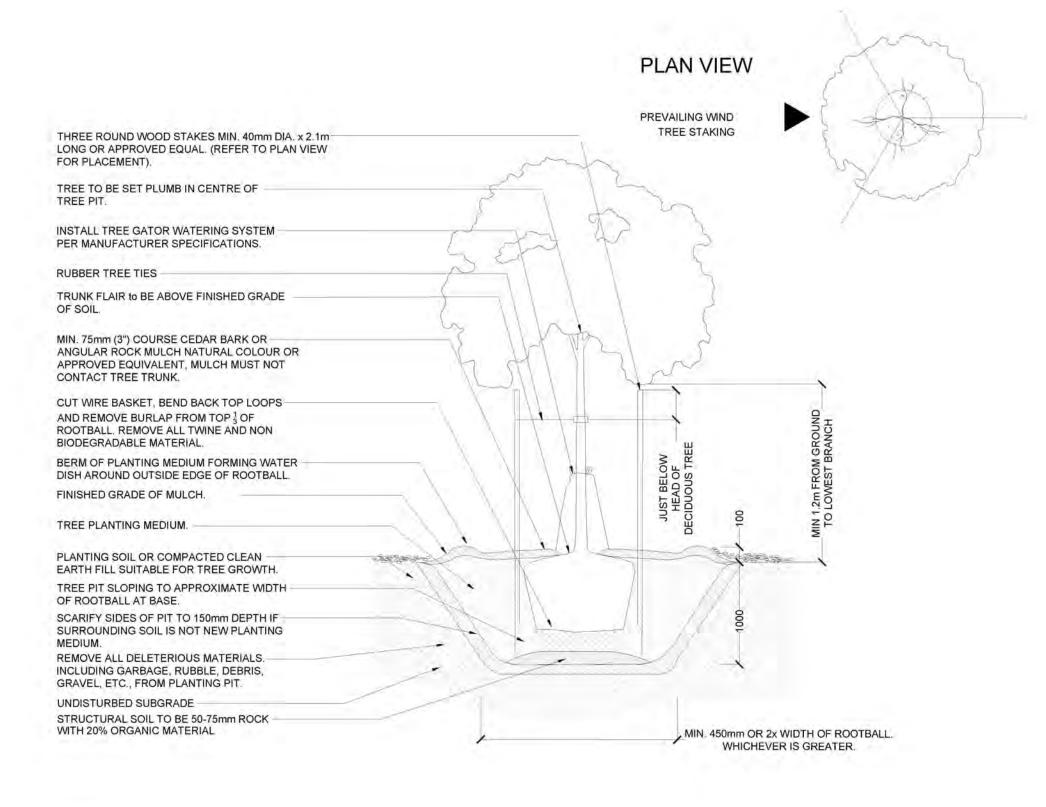
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DESIGNED BY: JJ

DRAWING TITLE: **REVEGETATION PLAN** SEMI-WET SITES


L-3.1



- 1. WATER THOROUGHLY AFTER INSTALLATION.
- . INSTALL TREE STAKES IF REQUIRED BY CLIENT. 3. REMOVE TREE RINGS AND STAKES TWO YEARS AFTER
- 4. DO NOT ALLOW AIR POCKETS TO FORM WHEN BACKFILLING.
- 5. POSITION CROWN OF ROOT BALL 50mm ABOVE FINISHED GRADE TO ALLOW FOR SETTLEMENT.
- 6. DEPTH OF ROOTBALL TO MATCH ORIGINAL ROOTBALL DEPTH ESTABLISHED IN THE NURSERY. ANY TREES PLANTED TOO LOW WILL BE RAISED AT THE CONTRACTOR'S EXPENSE.
- DO NOT DAMAGE OR CUT LEADER. 8. IF STAKING IS DEEMED NECESSARY REFER TO TREE STAKING
- 9. DO NOT WRAP TRUNK.
- 10. INSTALL TREE GATOR WATERING SYSTEM PER MANUFACTURER SPECIFICATIONS.
- 11. ALL TREE AND SHRUB PLANTING TO MEET THE CANADIAN LANDSCAPE STANDARD SPECIFICATIONS, CURRENT EDITION.

# 1 TREE PLANTING DETAIL

L3.2 1:30

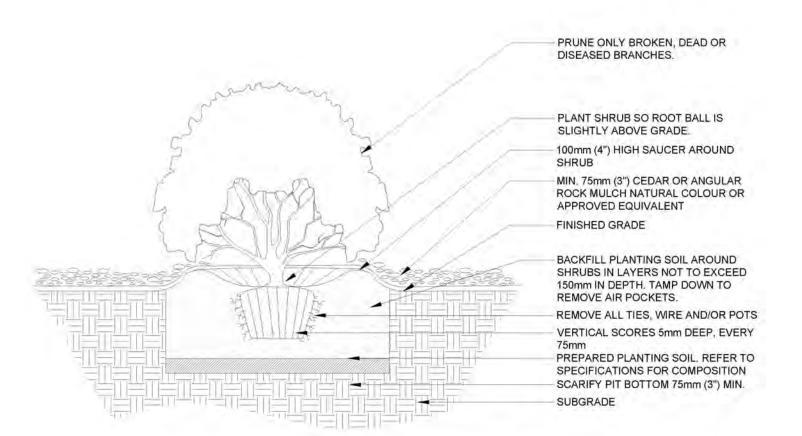

# 2 SHRUB PLANTING DETAIL

L3.2 1:30

# PLANT SCHEDULE SEMI-WET AREAS PER 500 - 1000 METERS

SYMBOL	CODE	BOTANICAL / COMMON NAME	CONT	CAL	SIZE	QTY
TREES						
	BET PAP	Betula papyrifera / Paper Birch		60mm		5
NAME OF THE PERSON OF THE PERS	PIN PON	Pinus ponderosa / Ponderosa Pine			2.0m HT.	7
	POP TRE	Populus tremuloides / Trembling Aspen	4.	60mm		15
0	POP TRI	Populus trichocarpa / Black Cottonwood	2.0m HT.			11
SYMBOL	CODE	BOTANICAL / COMMON NAME	CONT			QTY
SHRUBS	ACE GLA	Acer glabrum / Rocky Mountain Maple	#5 CONT.			8
0	AME SER	Amelanchier alnifolia / Saskatoon	#2 CONT.			13
	COR RE5	Cornus sericea / Red Osier Dogwood	#2 CONT.			34
	MAH AQU	Mahonia aquifolium / Oregon Grape	#2 CONT.			16
	PHI BLI	Philadelphus lewisii `Blizzard` / Blizzard Mockorange	#5 CONT.			10
0	ROS COM	Rosa acicularis / Prickly Rose	#2 CONT.			30
0	ROS NUT	Rosa nutkana / Nootka Rose	#2 CONT.			25
	SAL PUR	Salix purpurea `Nana` / Dwarf Arctic Willow	#2 CONT.			5
0	SAM RED	Sambucus racemosa / Red Elderberry	#2 CONT.			4
	SCH TST	Schoenoplectus acutus occidentalis / IndigenousTule - Bull Rush	#1 CONT.			11
	SHE ARG	Shepherdia argentea / Silver Buffaloberry	#2 CONT.			3
0	SPI BET	Spiraea betulifolia / Birch Leaf Spirea	#5 CONT.			5
	VIB AM2	Viburnum trilobum / Indigenous Highbush Cranberrybush	#2 CONT.			7


# PROPOSED HOT DRY SITE RECLAMATION SEED MIX

TIPI MOUNTAIN NATIVE RECLAMATION GRASS SEED MIX TO BE HYDROSEEDED WITH TACKIFIER AT 200 KG/HECTARE, FERTILIZER AT 250KG/HECTARE.

ALTERNATIVE MIX OR APPROVED EQUIVALENT:


REVEGETATION MIX BY TOP CROP CRANBROOK ITEM# FRXT6108

# LEGEND

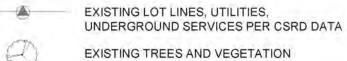

TO REMAIN - PROTECT IN PLACE PROPOSED VEGETATION REFER TO PLANT

SCHEDULE PROPOSED RECLAMATION SEED MIX AREAS - 150mm TOPSOIL AND HYDROSEED - REFER

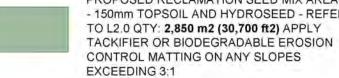

### **GENERAL NOTES:**

- 1. CONTRACTOR TO LOCATE AND PROTECT ALL EXISTING UTILITIES AND SERVICES, BC ONE CALL 1-800-474-6886.
- 2. ALL WORK AND MATERIALS ARE TO BE IN ACCORDANCE WITH THE CURRENT EDITIONS OF THE CITY OF SICAMOUS CONSTRUCTION STANDARDS, AND THE MASTER MUNICIPAL CONSTRUCTION DOCUMENTS (MMCD) REQUIREMENTS.
- 3. CONTRACTOR SHALL VERIFY SITE CONDITIONS PRIOR TO DEMOLITION OR CONSTRUCTION.
- 4. CONTRACTOR TO VERIFY ALL DIMENSIONS AND REPORT ANY DISCREPANCIES TO ENGINEER OR LANDSCAPE ARCHITECT. PROPERTY LINES TO BE VERIFIED PRIOR TO CONSTRUCTION.
- 5. CONTRACTOR IS RESPONSIBLE TO COORDINATE THE STAGING OF CONSTRUCTION ACTIVITIES AND WORK WITH ALL OTHER CONTRACTORS ONSITE, INCLUDING SLEEVING AND WEEPING TILE DOWNSPOUT LOCATIONS PRIOR TO HARDSCAPE /SOFTSCAPE INSTALLATION.
- 6. THE LANDSCAPE ARCHITECT WILL BE NOTIFIED MIN. 48 HOURS PRIOR TO COMMENCEMENT OF WORK.
- 7. THE QUANTITIES LISTED ARE ESTIMATES. CONTRACTOR TO VERIFY ALL QUANTITIES THROUGH SITE SURVEY AND REPORT ANY DISCREPANCIES TO ENGINEER OR LANDSCAPE ARCHITECT.
- 8. ANY CHANGES OR ALTERATIONS TO DRAWINGS SHALL BE APPROVED BY LANDSCAPE ARCHITECT.
- 9. CONTRACTOR TO CONFIRM ELEVATION, LOCATION, AND GRADIENT OF SURROUNDING GRADES AND PROVIDE A SMOOTH TRANSITION.
- 10. CONTRACTOR TO BE REGISTERED WITH WORKSAFE BC.

# PLANTING NOTES:

- 1. REFER TO PLANT SCHEDULE FOR DETAILED SPECIES INFORMATION. NO PLANT SUBSTITUTIONS ARE PERMITTED WITHOUT WRITTEN APPROVAL BY LANDSCAPE ARCHITECT.
- 2. CONFINE EQUIPMENT AND WORKERS TO LIMIT OF DISTURBANCE WITHIN PROJECT BOUNDARY.
- 3. MINIMUM 150mm OF TOPSOIL AND SEED MIX TO BE PLANTED ADJACENT TO DISTURBED AREAS AND OTHER AREAS OF NEW CONSTRUCTION.
- 4. PLANT MATERIAL SHALL MEET ALL REQUIREMENTS OF THE LATEST EDITION OF THE CANADIAN NURSERY TRADES ASSOCIATION GUIDE SPECIFICATIONS FOR NURSERY STOCK UNLESS OTHERWISE SPECIFIED.
- 5. SUPPLY 75mm OF NATURAL COLOUR CEDAR BARK MULCH OR ANGULAR ROCK MULCH TO ALL PROPOSED TREE AND SHRUB BEDS.
- 6. INSTALL TREE GATOR BAG SLOW RELEASE WATERING SYSTEM (OR APPROVED EQUIVALENT) ON ALL PROPOSED
- TREES AND TREE GATOR JR. PRO LOW PROFILE SLOW RELEASE WATERING SYSTEM (OR APPROVED EQUIVALENT) ON
- ALL PROPOSED CONIFEROUS TREES.
- 6. TREES AND SHRUBS TO BE GUARANTEED FOR 1 FULL GROWING SEASONS BY CONTRACTOR. ALL REPLACEMENTS TO BE AT CONTRACTOR'S EXPENSE. SUBSTITUTIONS TO BE APPROVED BY LANDSCAPE ARCHITECT.

# TOPSOIL NOTES:

- 1. GROWING MEDIUM FOR ALL TREE, SHRUB, ANDPERENNIAL BEDS IS TO MEET THE CANADIAN LANDSCAPE SPECIFICATION UNDER THE DESIGNATION 2P.
- 2. GROWING MEDIUM SHOULD BE CERTIFIED TO IT'S ORIGIN AND VIRTUALLY FREE OF INVASIVE PLANT SEEDS, THEIR REPRODUCTIVE PARTS AND ROOTS BUILDING MATERIALS, INVASIVE OR NOXIOUS PLANTS, NON COMPOSTED WOOD, WOOD WASTE, INSECT PESTS, PLANT PATHOGENIC ORGANISMS, CHEMICAL POLLUTANTS OR SUBSTANCES AT LEVELS TOXIC TO PLANTS, AND OTHER EXTRANEOUS MATERIALS THAT DETRACT FROM DESIRABLE PHYSICAL AND CHEMICAL PROPERTIES REQUIRED FOR LANDSCAPING PURPOSES.
- LOAM: NATURAL, FERTILE, FRIABLE, AGRICULTURAL
- SOIL MEETING FOLLOWING REQUIREMENTS:
- NOT LESS THAN 6% ORGANIC MATERIAL. PH VALUE RANGING FROM 5.9 TO 7.0.
- NON-TOXIC TO PLANT GROWTH. E.C.- SALINITY READING NOT EXCEEDING 1.5.
- SOIL TEXTURE: LOAM SOIL AS DEFINED BY
- CANADIAN SYSTEM OF SOIL CLASSIFICATION.

PEAT MOSS: DECOMPOSED PLANT MATERIAL, FAIRLY ELASTIC AND HOMOGENEOUS, FREE OF DECOMPOSED COLLOIDAL RESIDUE, WOOD, SULPHUR, AND IRON, MINIMUM OF 80% ORGANIC MATTER BY MASS; PH VALUE BETWEEN 4.5 AND 6.0.

# PROJECT:


# SHUSWAP NORTH **OKANAGAN RAIL TRAIL BASELINE TREATMENTS**

LOCATION: SICAMOUS - ENDERBY, BC



NORTH



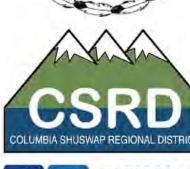



LANDSCAPE ARCHITECT



GOLDEN, BC



ORIGINAL SHEET SIZE ARCH D 24X36

12.5m NORTH SCALE 1:250

ISSUED FOR: TENDER

# DATE: 2024-11-19 NOT FOR CONSTRUCTION

REVISIONS: NO. DESCRIPTION.	DATE.	BY.
1. SPLATSIN ENGAGEMENT	2023-02-03	EL/J.
2. COMMITTEE REVIEW	2024-07-30	JJ
3. ISSUED FOR TENDER	2024-11-19	JJ

DESIGNED BY: JJ

DRAWING TITLE : **REVEGETATION PLAN SEMI-WET SITES** 

L-3.2

Project #

Issued for Tender - Unit Price Schedule HOT DRY AGRICULTURAL SITE - PER BASELINE CONCEPT (500 - 1000m)

2024-11-19

Item / Description	Unit	Qty	Unit Cost	Total
1. CONTRACTOR USE OF SITE, SITE ACCESS, AND SITE SURVEY				
i. Contractor mobilization, establishment of site security fencing, secure staging compound, installation of stockpile areas, tree protection fencing, maintain temporary access routes, dust control, erosion and sediment control, safety signage, detours, and haul roads as required. Reinstatement of all areas, surfaces and utilities disturbed. Remove construction debris and demobilization. Contractor to submit location of staging area, stockpile location and sizes, haul routes to Client representatives and Landscape Architect for approval prior to mobilization.	l.sum	1		
		Sub	-Total Section 1	
2. REVEGETATION + LANDSCAPE				
A. Trees i. Betula papyrifera / Paper Birch				
*Per Landscape drawings and specifications.	ea.	2		
ii. Fraxinus pennsylvanica `Prairie Spire` / Prairie Spire Ash		_		
*Per Landscape drawings and specifications.	ea.	9		
iii. Malus domestica / Local Acclimatized Apple Species				
*Per Landscape drawings and specifications.	ea.	2		
iv. Pinus ponderosa / Ponderosa Pine				
*Per Landscape drawings and specifications.	ea.	3		
v. Populus sargentii / Plains Cottonwood				
*Per Landscape drawings and specifications.	ea.	3		
vi. Populus tremuloides / Trembling Aspen				
*Per Landscape drawings and specifications.	ea.	9		
vii. Pseudotsuga menziesii / Douglas Fir				
*Per Landscape drawings and specifications.	ea.	3		

Project #

Issued for Tender - Unit Price Schedule HOT DRY AGRICULTURAL SITE - PER BASELINE CONCEPT (500 - 1000m)

2024-11-19

tem / Description	Unit	Qty	Unit Cost	Total
B. Shrubs, Grasses, Perennials i. Acer glabrum / Rocky Mountain Maple				
*Per Landscape drawings and specifications.	ea.	5		
ii. Amelanchier alnifolia / Saskatoon	ca.	J _		-
*Per Landscape drawings and specifications.	ea.	10		
iii. Cornus sericea / Red Osier Dogwood	ca.	-		-
*Per Landscape drawings and specifications.	ea.	9		
iv. Mahonia aquifolium / Oregon Grape	ea.	· -		-
*Per Landscape drawings and specifications.	ea.	14		
v. Philadelphus lewisii `Blizzard` / Blizzard Mockorange	ca.	-		
*Per Landscape drawings and specifications.	ea.	6		
vi. Physocarpus opulifolius / Indigenous Ninebark	ca.	-		-
*Per Landscape drawings and specifications.	ea.	5		
vii. Rosa acicularis / Prickly Rose	ca.	J <u>-</u>		-
*Per Landscape drawings and specifications.	ea.	3		
viii. Rosa nutkana / Nootka Rose	cu.	<u> </u>		
*Per Landscape drawings and specifications.	ea.	9		
ix. Salix purpurea `Nana` / Dwarf Arctic Willow	cu.	<u> </u>		
*Per Landscape drawings and specifications.	ea.	5		
x. Shepherdia argentea /Silver Buffaloberry	ou.	_		
*Per Landscape drawings and specifications.	ea.	5		
xi. Viburnum trilobum / Indigenous Highbush Cranberry	ca.	-		-
*Per Landscape drawings and specifications.	ea.	2		
	ou.			-

Project #

2024-11-19

Issued for Tender - Unit Price Schedule

HOT DRY AGRICULTURAL SITE - PER BASELINE CONCEPT (500 - 1000m)

Sicamous - Enderby, BC V0E 1V0

Item / Description	Unit	Qty	Unit Cost	Total
C. Landscape Items				
i. Feature Boulders				
*Per Landscape drawings, spaced approximately every 200m. Supply and install local source feature boulders approx. 1000mm L x 500mm H x 500mm W.	ea.	5		
ii. Tree Gator Watering Bag (Deciduous Trees)				
*Per Landscape drawings. Supply and install Gator Bag Pro or approved equivalent.	e.a.	24		
iii. Tree Gator Jr. Watering Bag (Coniferous Trees)				
*Per Landscape drawings. Supply and install Gator Bag Pro or approved equivalent.	e.a.	6		
iv. Biodegradable Erosion Control Matting			_	
*Supply and installation of 100% Biodegradable erosion control matting and wattles per specifications.	sm.	100		
D. Planting Medium - Topsoil				
i. Planting Medium for Tree and Shrub Beds				
*Supply and install screened topsoil to 1000mm depth per specifications including soil amendments per landscape drawings and specifications to all planting areas.	cu.m	125		
ii. Topsoil for reclamation areas				
*Supply and install screened topsoil to 150mm depth in reclamation seed mix areas.	cu.m	415		
E. Landscape Mulch i. Bark Mulch				
*Supply and installation of course natural colour cedar bark or non-flammable mulch per landscape drawings and specifications.	sq.m	75		
		Sub	-Total Section 2	
3. LANDSCAPE MAINTENANCE - 1 GROWING SEASON FROM SUBSTANT	IAL COI	MPLETIO	ON	
i. Landscape Maintenance				
*Contractor to perform landscape maintenance, watering, and removal of noxious and invasive species per landscape drawings and specifications.				
urawings and specifications.	l.sum	1		
		Sub	-Total Section 3	
			Total	

NOTE:

<sup>\*</sup> Contractor is to ensure all items listed above are supplied, installed, and maintained in accordance with City of Enderby, District of Sicamous, and Development Guidelines & Standard Specifications and MMCD (Current Edition)

<sup>\*</sup> All quantities and areas are to be confirmed prior to construction

Project #

Issued for Tender - Unit Price Schedule

2024-11-19

PROTECTION OF ARCH RESOURCES / RIPARIAN SITE - PER BASELINE (500 - 1000m)

Item / Description	Unit	Qty	Unit Cost	Total
1. CONTRACTOR USE OF SITE, SITE ACCESS, AND SITE SURVEY				
i. Contractor mobilization, establishment of site security fencing, secure staging compound, installation of stockpile areas, tree protection fencing, maintain temporary access routes, safety signage, detours, and haul roads as required. Reinstatement of all areas, surfaces and utilities disturbed. Remove construction debris and demobilization. Contractor to submit location of staging area, stockpile location and sizes, haul routes to Client representatives and Landscape Architect for approval prior to mobilization.	l.sum	1		
		Su	b-Total Section 1	
2. REVEGETATION + LANDSCAPE				
A. Trees i. Betula papyrifera / Paper Birch				
*Per Landscape drawings and specifications.	ea.	4		
ii. Pinus ponderosa / Ponderosa Pine	ca.	7	-	
*Per Landscape drawings and specifications.	ea.	2		
iii. Populus tricocarpa / Black Cottonwood	ou.	_		
*Per Landscape drawings and specifications.	ea.	3		
iv. Populus tremuloides / Trembling Aspen	ou.	Ü		
*Per Landscape drawings and specifications.	ea.	5		
v. Pseudotsuga menziesii / Douglas Fir	ou.	ŭ		
*Per Landscape drawings and specifications.	ea.	1		

Project #

Issued for Tender - Unit Price Schedule

2024-11-19

PROTECTION OF ARCH RESOURCES / RIPARIAN SITE - PER BASELINE (500 - 1000m)

m / Description	Unit	Qty	Unit Cost	Total
B. Shrubs, Grasses, Perennials i. Acer glabrum / Rocky Mountain Maple				
*Per Landscape drawings and specifications.	ea.	5		
ii. Amelanchier alnifolia / Saskatoon	ca.	٠.		
*Per Landscape drawings and specifications.	ea.	18		
iii. Cornus sericea / Red Osier Dogwood	cu.			
*Per Landscape drawings and specifications.	ea.	12		
iv. Oplopanax horridus / Devil's Club	ou.	12 -		
*Per Landscape drawings and specifications.	ea.	12		
v. Philadelphus lewisii `Blizzard` / Blizzard Mockorange	cu.	12.		
*Per Landscape drawings and specifications.	ea.	5		
vi. Ribes oxycanthoides / Gooseberry	ca.	٠.		
*Per Landscape drawings and specifications.	ea.	7		
vii. Rosa acicularis / Prickly Rose	ca.	٠.		
*Per Landscape drawings and specifications.	ea.	17		
viii. Rosa nutkana / Nootka Rose	ca.	٠, -		
*Per Landscape drawings and specifications.	ea.	9		
ix. Salix purpurea `Nana` / Dwarf Arctic Willow	ca.	•		
*Per Landscape drawings and specifications.	ea.	9		
x. Shepherdia argentea / Silver Buffaloberry	ca.	•		
*Per Landscape drawings and specifications.	ea.	9		
xi. Viburnum trilobum / Indigenous Highbush Cranberry	ea.	9 _		
*Per Landscape drawings and specifications.	ea.	3		
	ca.	٠.		
C. RIPAIRAN IMPROVEMENTS i. Live staking				
*Site specific, requires fine scale study. Native, site appropriate live stake cuttings prepared, installed, and spaced per specifications.	sm.	750		
ii. Biodegradable Erosion Control Matting	5111.	.00		
*Supply and installation of 100% Biodegradable erosion control matting and wattles per specifications.	em	750		
matting and watties per specifications.	sm.	750		

Project #

Issued for Tender - Unit Price Schedule

2024-11-19

# PROTECTION OF ARCH RESOURCES / RIPARIAN SITE - PER BASELINE (500 - 1000m)

Sicamous - Enderby, BC V0E 1V0

Item / Description	Unit	Qty	<b>Unit Cost</b>	Total
D. Landscape Items				
i. Feature Boulders				
*Per Landscape drawings, spaced approximately every 200m. Supply and install local source feature boulders approx. 1000mm L x 500mm H x 500mm W.	ea.	5		
ii. Tree Gator Watering Bag (Deciduous Trees)		•		
*Per Landscape drawings. Supply and install Gator Bag Pro or approved equivalent.	e.a.	12		
iii. Tree Gator Jr. Watering Bag (Coniferous Trees)		-		
*Per Landscape drawings. Supply and install Gator Bag Pro or				
approved equivalent.	e.a.	3		
E. Planting Medium - Topsoil				
i. Planting Medium for Tree and Shrub Beds				
*Supply and install screened topsoil to 1000mm depth per specifications including soil amendments per landscape drawings and specifications to all planting areas.	cu.m	125		
ii. Topsoil for reclamation areas		-		
*Supply and install screened topsoil to 150mm depth in reclamation seed mix areas.	cu.m	325		
F. Landscape Mulch i. Bark Mulch		•		
*Supply and installation of course natural colour cedar bark or non-flammable mulch per landscape drawings and specifications.	sq.m	165		
		Sub	-Total Section 2	
3. LANDSCAPE MAINTENANCE - 1 GROWING SEASON FROM SUBSTAN	TIAL COI	MPLETIC	ON	
i. Landscape Maintenance				
*Contractor to perform landscape maintenance, watering, and remaoval of noxious and invasive species per landscape				
drawings and specifications.	l.sum	1 .		
		Sub	-Total Section 3	
			Total	

# NOTE:

<sup>\*</sup> Contractor is to ensure all items listed above are supplied, installed, and maintained in accordance with City of Enderby, District of Sicamous, and Development Guidelines & Standard Specifications and MMCD (Current Edition)

<sup>\*</sup> All quantities and areas are to be confirmed prior to construction

Project #

Issued for Tender - Unit Price Schedule SEMI-WET SITE - PER BASELINE (500 - 1000m)

2024-11-19

Item / Description	Unit	Qty	Unit Cost	Total
1. CONTRACTOR USE OF SITE, SITE ACCESS, AND SITE SURVEY				
i. Contractor mobilization, establishment of site security fencing, secure staging compound, installation of stockpile areas, tree protection fencing, maintain temporary access routes, safety signage, detours, and haul roads as required. Reinstatement of all areas, surfaces and utilities disturbed. Remove construction debris and demobilization. Contractor to submit location of staging area, stockpile location and sizes, haul routes to Client representatives and Landscape Architect for approval prior to mobilization.	l.sum	1		
		Sul	o-Total Section 1	
2. REVEGETATION + LANDSCAPE				
A. Trees i. Betula papyrifera / Paper Birch				
*Per Landscape drawings and specifications.	ea.	5		
ii. Pinus ponderosa / Ponderosa Pine	ca.	3		
*Per Landscape drawings and specifications.	ea.	7		
iii. Populus tricocarpa / Black Cottonwood	ca.	,		
*Per Landscape drawings and specifications.	00	11		
iv. Populus tremuloides / Trembling Aspen	ea.	11		
*Per Landscape drawings and specifications.	00	45		
v. Pseudotsuga menziesii / Douglas Fir	ea.	15		
*Per Landscape drawings and specifications.	ea.	3		

Project #

2024-11-19

Issued for Tender - Unit Price Schedule SEMI-WET SITE - PER BASELINE (500 - 1000m)

tem / Description	Unit	Qty	Unit Cost	Total
B. Shrubs, Grasses, Perennials i. Acer glabrum / Rocky Mountain Maple				
*Per Landscape drawings and specifications.	ea.	8		
ii. Amelanchier alnifolia / Saskatoon	ca.	•		
*Per Landscape drawings and specifications.	ea.	13		
iii. Cornus sericea / Red Osier Dogwood		10 -		
*Per Landscape drawings and specifications.	ea.	34		
iv. Mahonia aquifolium / Oregon Grape		J <del>4</del> _		
*Per Landscape drawings and specifications.	ea.	16		
v. Philadelphus lewisii `Blizzard` / Blizzard Mockorange	ea.	-		
*Per Landscape drawings and specifications.	ea.	10		
vi. Rosa acicularis / Prickly Rose		10 _		
*Per Landscape drawings and specifications.	ea.	20		
vii. Rosa nutkana / Nootka Rose		30 _		
*Per Landscape drawings and specifications.	ea.	25		
ix. Salix purpurea `Nana` / Dwarf Arctic Willow		25 _		
*Per Landscape drawings and specifications.	ea.	_		
x. Sambucus racemosa / Indigenous Elderberry		5 _		
*Per Landscape drawings and specifications.	ea.	ı		
xi. Schoenoplectus acutus occidentalis / Indigenous Tule - Bull Rush		4 _		
*Per Landscape drawings and specifications.	ea.	4.4		
xii. Shepherdia argentea /Silver Buffaloberry		11 _		
*Per Landscape drawings and specifications.	ea.	•		
xiii. Spiraea betulifolia / Birch Leaf Spirea		9 _		
*Per Landscape drawings and specifications.	ea.	_		
xiv. Viburnum trilobum / Indigenous Highbush Cranberry		5_		
*Per Landscape drawings and specifications.	ea.	_		
		7 _		

Project #

Issued for Tender - Unit Price Schedule SEMI-WET SITE - PER BASELINE (500 - 1000m)

2024-11-19

Sicamous - Enderby, BC V0E 1V0

tem / Description	Unit	Qty	<b>Unit Cost</b>	Total		
C. RIPAIRAN IMPROVEMENTS						
i. Live staking						
*Site specific, requires fine scale study. Native, site appropriate live stake cuttings prepared, installed, and spaced per specifications.		400				
ii. Biodegradable Erosion Control Matting	sm.	100				
*Supply and installation of 100% Biodegradable erosion control matting and wattles per specifications.	sm.	100				
D. Landscape Items i. Feature Boulders						
*Per Landscape drawings, spaced approximately every 200m. Supply and install local source feature boulders approx. 1000mm L x 500mm H x 500mm W.	ea.	5				
iii. Tree Gator Watering Bag (Deciduous Trees)						
*Per Landscape drawings. Supply and install Gator Bag Pro or approved equivalent.	e.a.	31				
iv. Tree Gator Jr. Watering Bag (Coniferous Trees)						
*Per Landscape drawings. Supply and install Gator Bag Pro or approved equivalent.	e.a.	7				
E. Planting Medium - Topsoil						
i. Planting Medium for Tree and Shrub Beds						
*Supply and install screened topsoil to 1000mm depth per specifications including soil amendments per landscape drawings and specifications to all planting areas.	cu.m	175				
ii. Topsoil for reclamation areas						
*Supply and install screened topsoil to 150mm depth in reclamation seed mix areas.	cu.m	330				
F. Landscape Mulch i. Bark Mulch						
*Supply and installation of course natural colour cedar bark or non-flammable mulch per landscape drawings and specifications.	sq.m	150				
		Sul	o-Total Section 2			
3. LANDSCAPE MAINTENANCE - 1 GROWING SEASON FROM SUBSTANTIAL COMPLETION						
i. Landscape Maintenance						
*Contractor to perform landscape maintenance, watering, and removal of noxious and invasive species per landscape drawings and specifications.	l.sum	1				
		Sul	o-Total Section 3			
			Total			

NOTE:

<sup>\*</sup> Contractor is to ensure all items listed above are supplied, installed, and maintained in accordance with City of Enderby, District of Sicamous, and Development Guidelines & Standard Specifications and MMCD (Current Edition)

<sup>\*</sup> All quantities and areas are to be confirmed prior to construction

# NEXT STEPS

- FINAL PLANTINGS ENDERBY TEST SECTION (Spring 2025)
  + Volunteer/Collaboration Opportunities
- REVEGETATION IMPLEMENTATION (Spring 2025)

  + Impacted Areas adjacent to private homes (Sicamous Narrows)
- RE-VEGETATION PRESCRIPTION IMPLEMENTATION:
  - + Natural Areas / Remote Areas Baseline Planting (Spring 2025/26+)
- PHASING AND GRANT FUNDING APPLICATIONS (Feb 2025)
- LONG TERM STRATEGY FOR INVASIVE PLANT MITIGATION AND ONGOING MAINTENANCE








**Technical Criteria** 

-Concrete Footing with 18" Sono Tube or larger helical wil xl plate -Connections with tamper proof hardware concrete (or helical plat) to steel. -20,000 lbs bearing substrait

\*final design with additional surrounding artwork and engineering





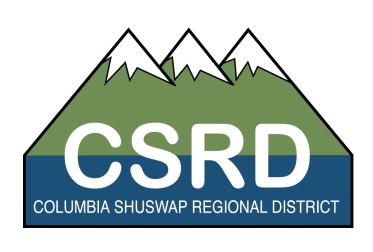



Steel Stump of tree

-Top same diameter as the base of the carving

-animal and plant names and images etched into

-permalac clear applied to both steel and wood